



BASEMENT FIRE PROTECTION DEMOLITION PLAN  
1/8"=1'-0"

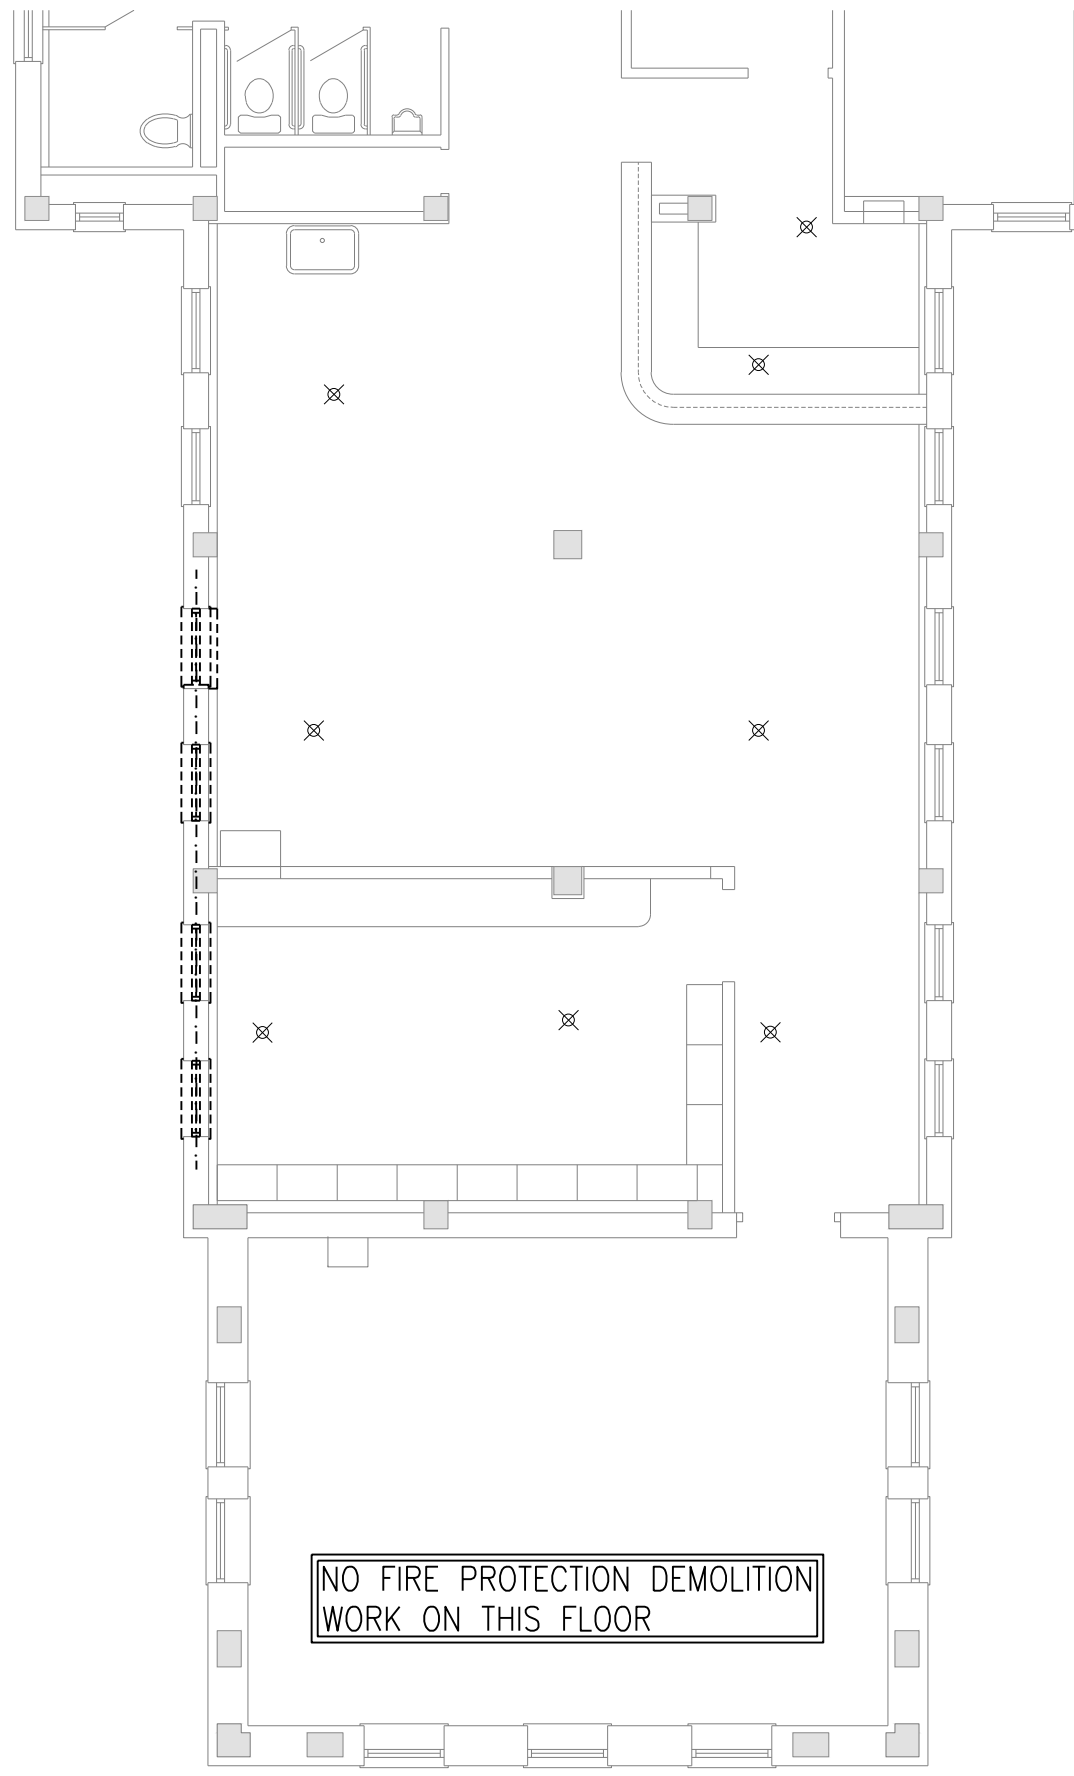


FIRST FLOOR FIRE PROTECTION DEMOLITION PLAN  
1/8"=1'-0"

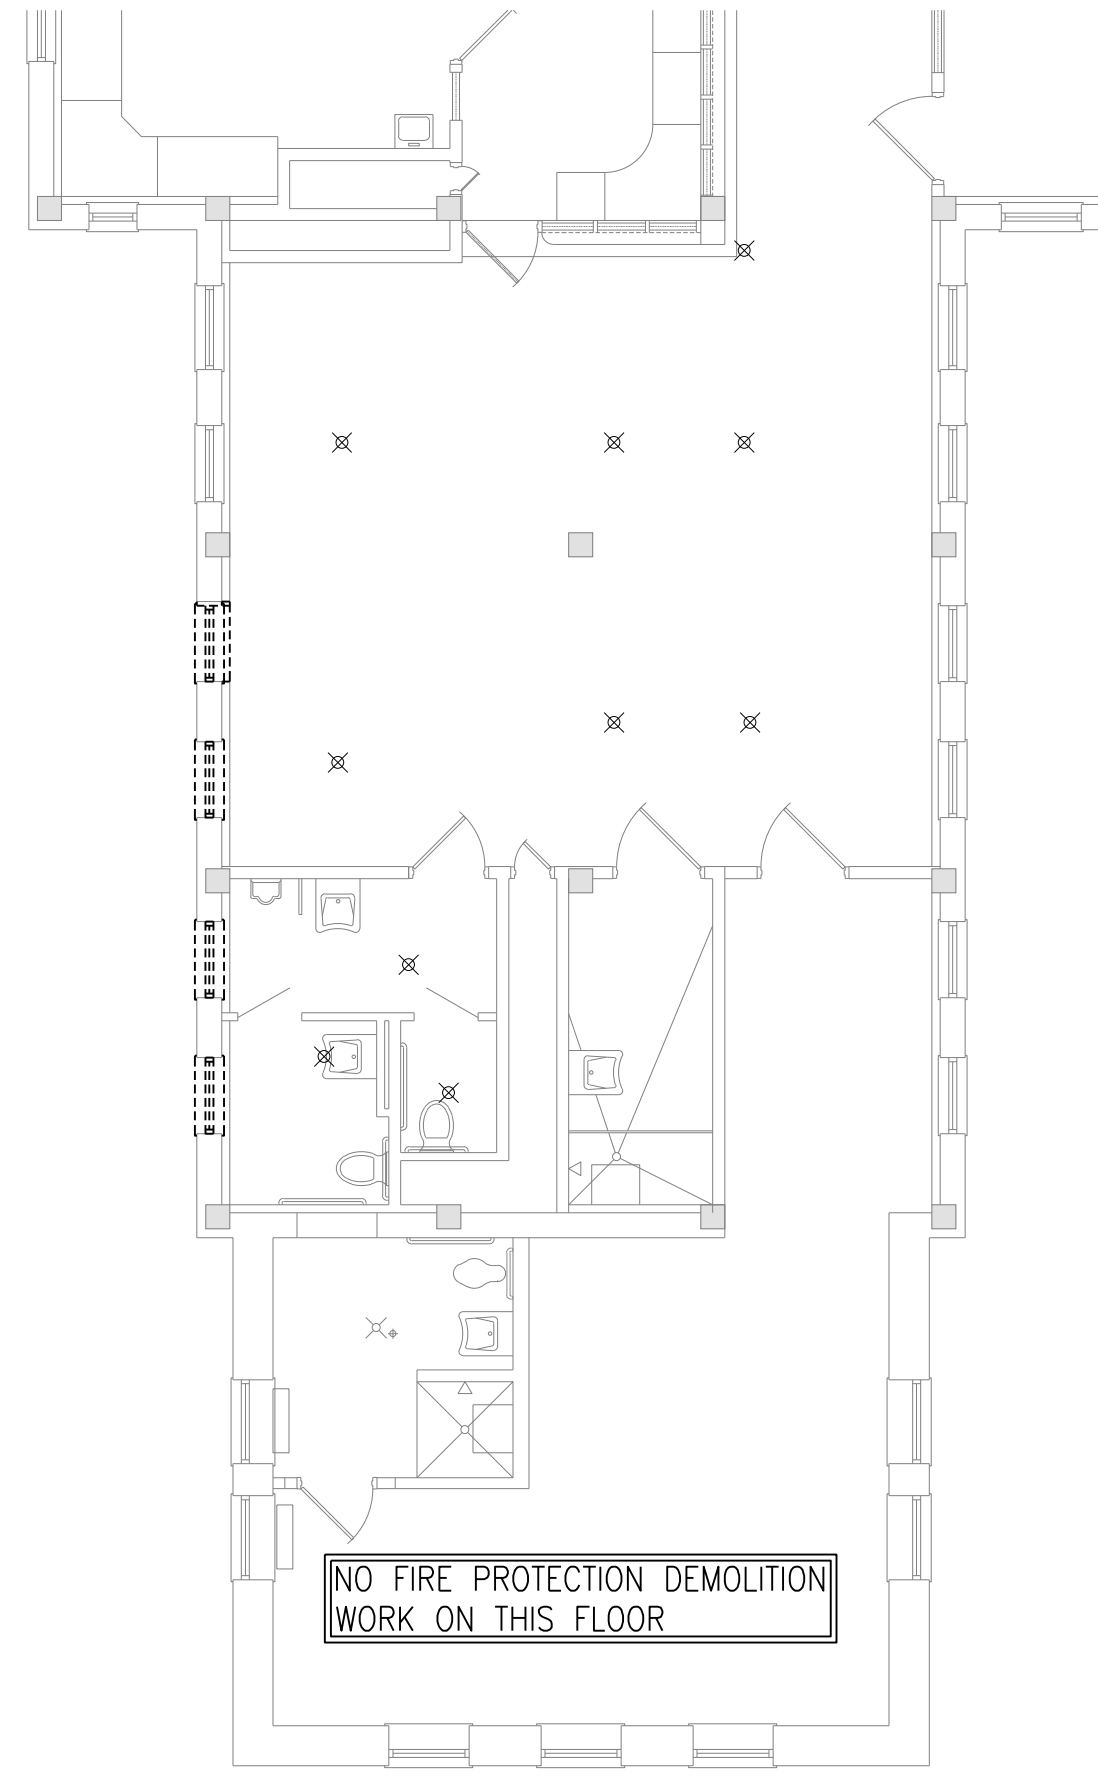


SECOND FLOOR FIRE PROTECTION DEMOLITION PLAN  
1/8"=1'-0"


- FIRE PROTECTION DEMOLITION NOTES:**
- DEMOLITION DRAWINGS ARE DIAGRAMMATIC ONLY AND ARE BASED ON FIELD OBSERVATION AND EXISTING RECORD DRAWINGS. CONTRACTOR SHALL VERIFY ALL EXISTING CONDITIONS PRIOR TO BEGINNING WORK AND NOTIFY THE ARCHITECT/ ENGINEER OF ANY DISCREPANCIES BETWEEN THE "AS-BUILT" CONDITIONS AND THESE DRAWINGS. PROVIDE ADDITIONAL DEMOLITION AS REQUIRED BASED ON FIELD CONDITIONS.
  - THIS CONTRACTOR IS RESPONSIBLE FOR REMOVAL AND RE-INSTALLING OF EXISTING CEILING TILE NOT REMOVED BY THE GENERAL CONTRACTOR FOR THE DEMOLITION OF EXISTING FIRE PROTECTION PIPING, SPRINKLER HEADS, EQUIPMENT, ETC. VERIFY WITH ARCHITECTURAL PLANS FOR CEILING WORK BY THE GENERAL CONTRACTOR. ANY CEILING TILE OR GRID DAMAGED DURING CONSTRUCTION SHALL BE REPLACED WITH NEW BY THIS CONTRACTOR.
  - THIS CONTRACTOR SHALL OPEN ALL WALLS AND/OR CEILINGS FOR DEMOLITION OF EXISTING FIRE PROTECTION PIPING, SPRINKLER HEADS, EQUIPMENT, ETC. AS REQUIRED.
  - THIS CONTRACTOR IS RESPONSIBLE FOR PATCHING ALL HOLES/WALLS AND OR CEILINGS FROM DEMOLISHED FIRE PROTECTION PIPING, SPRINKLER HEADS, EQUIPMENT, ETC. IN FLOORS, WALLS, AND CEILINGS TO MATCH EXISTING.
- DISCONNECT AND REMOVE EXISTING SPRINKLER HEAD. CAP PIPE AT MAIN.

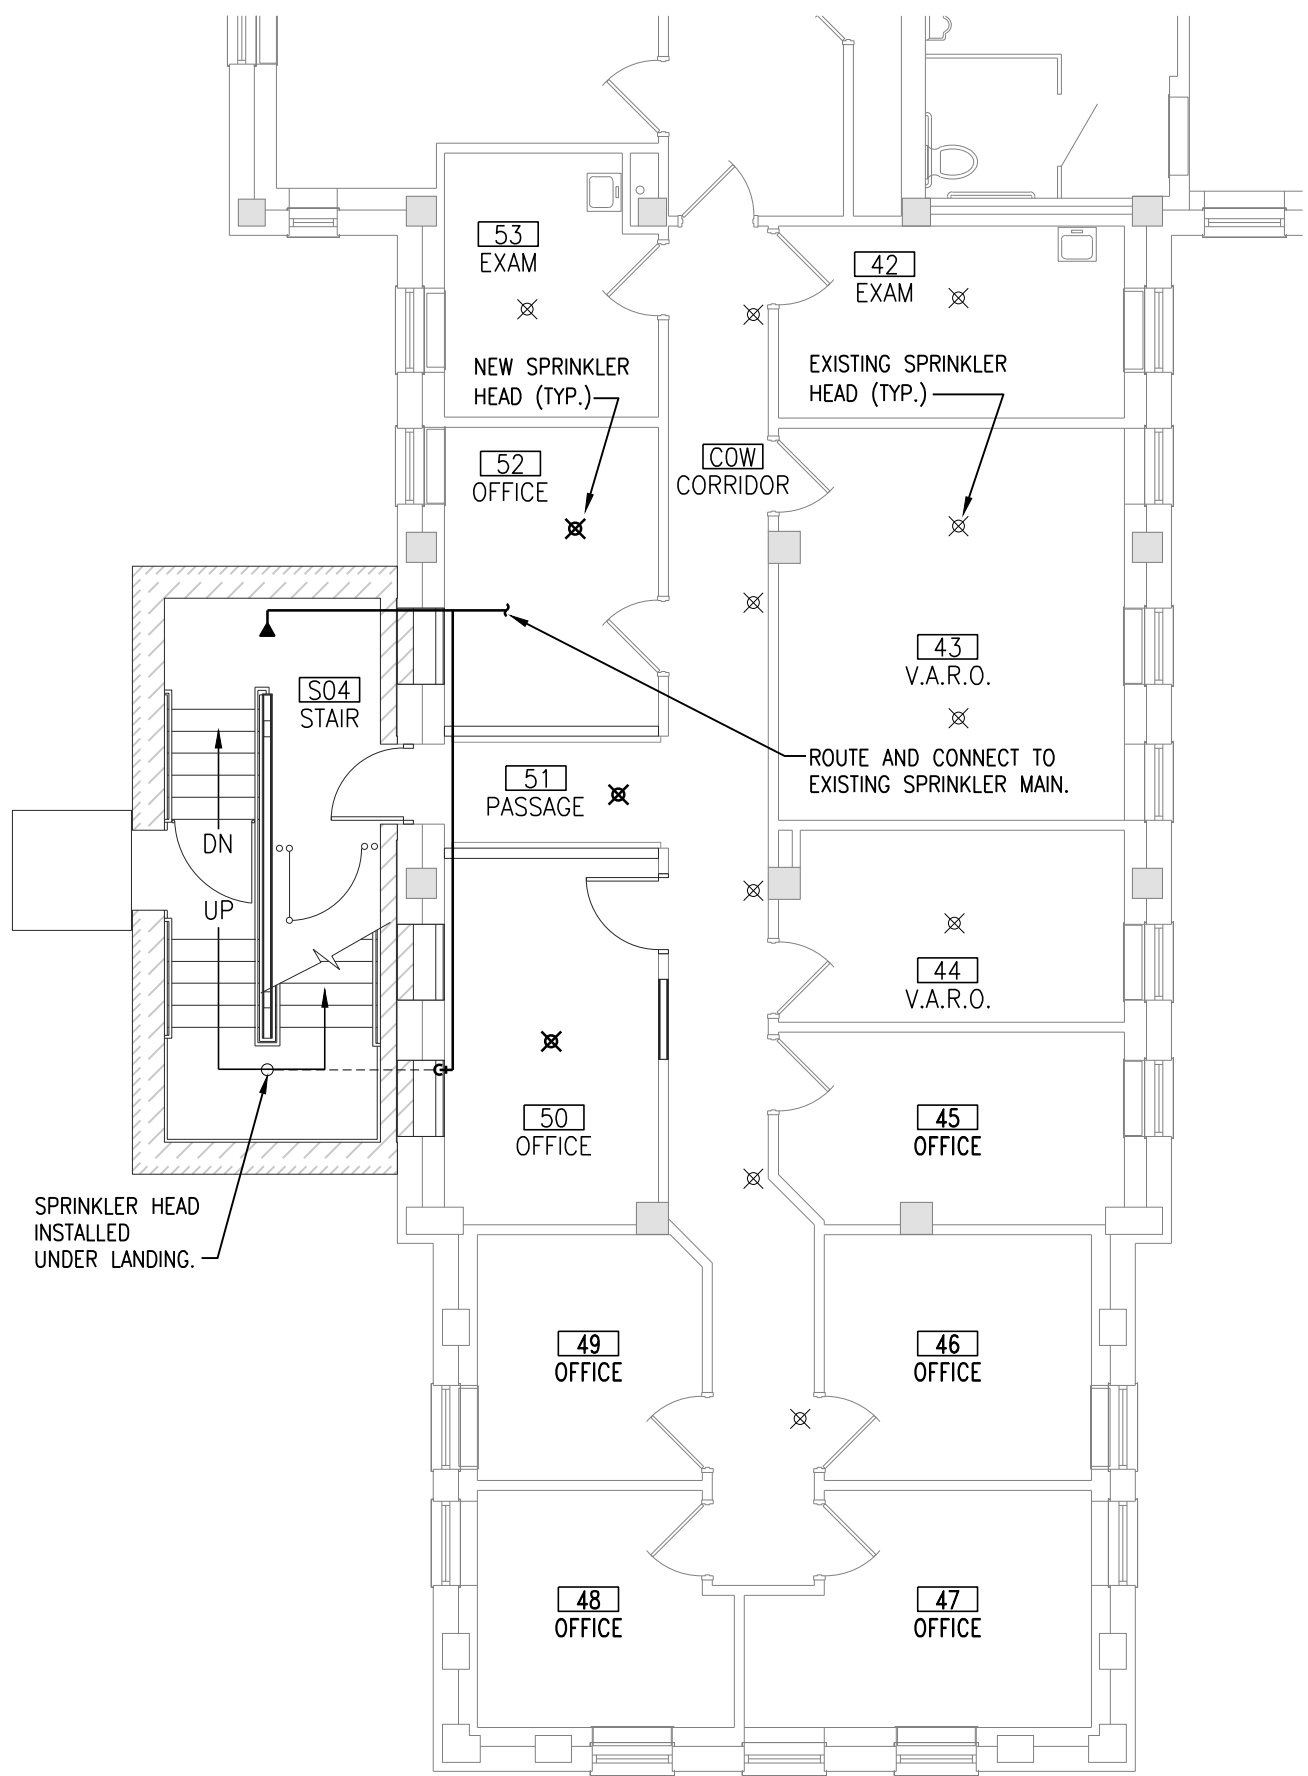

BASEMENT FIRE PROTECTION REMODELING PLAN  
1/8"=1'-0"

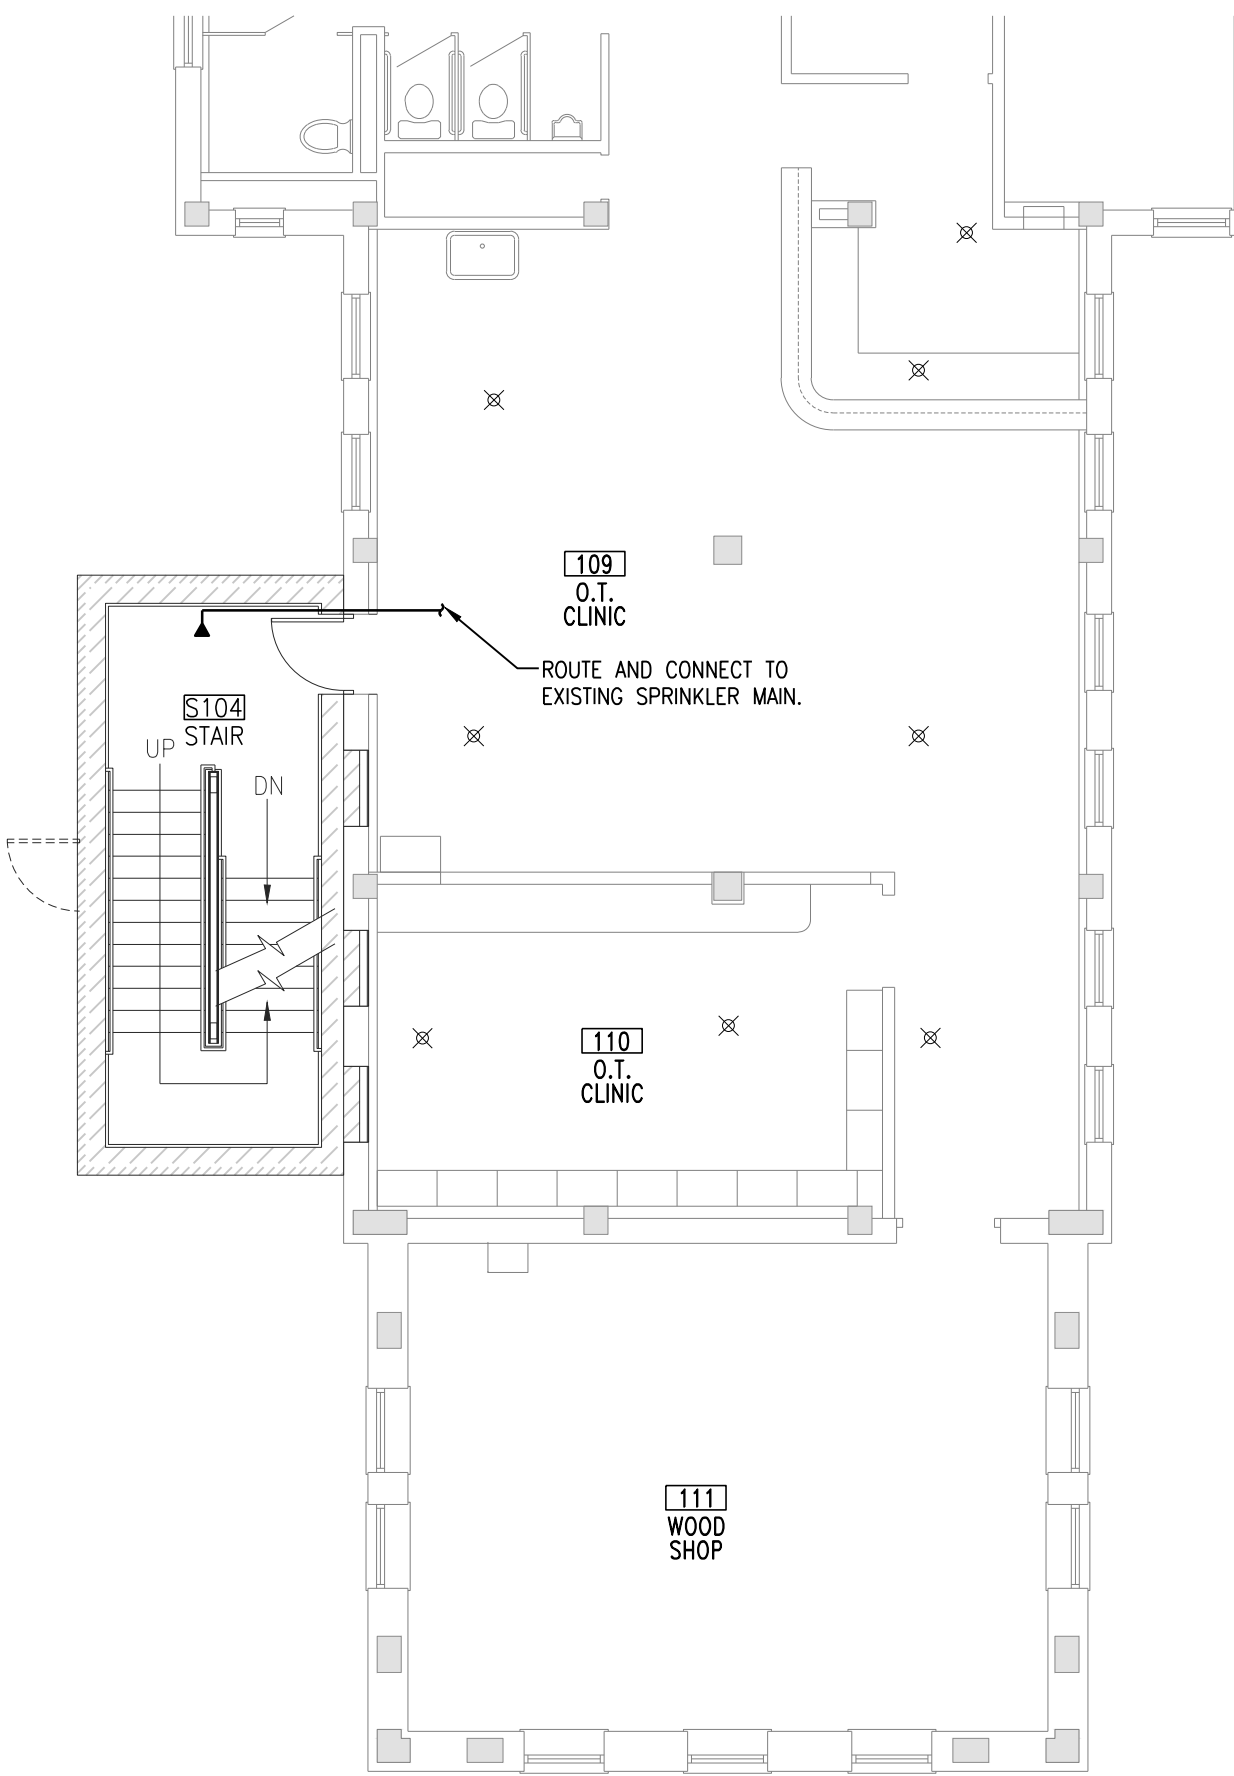


FIRST FLOOR FIRE PROTECTION REMODELING PLAN  
1/8"=1'-0"

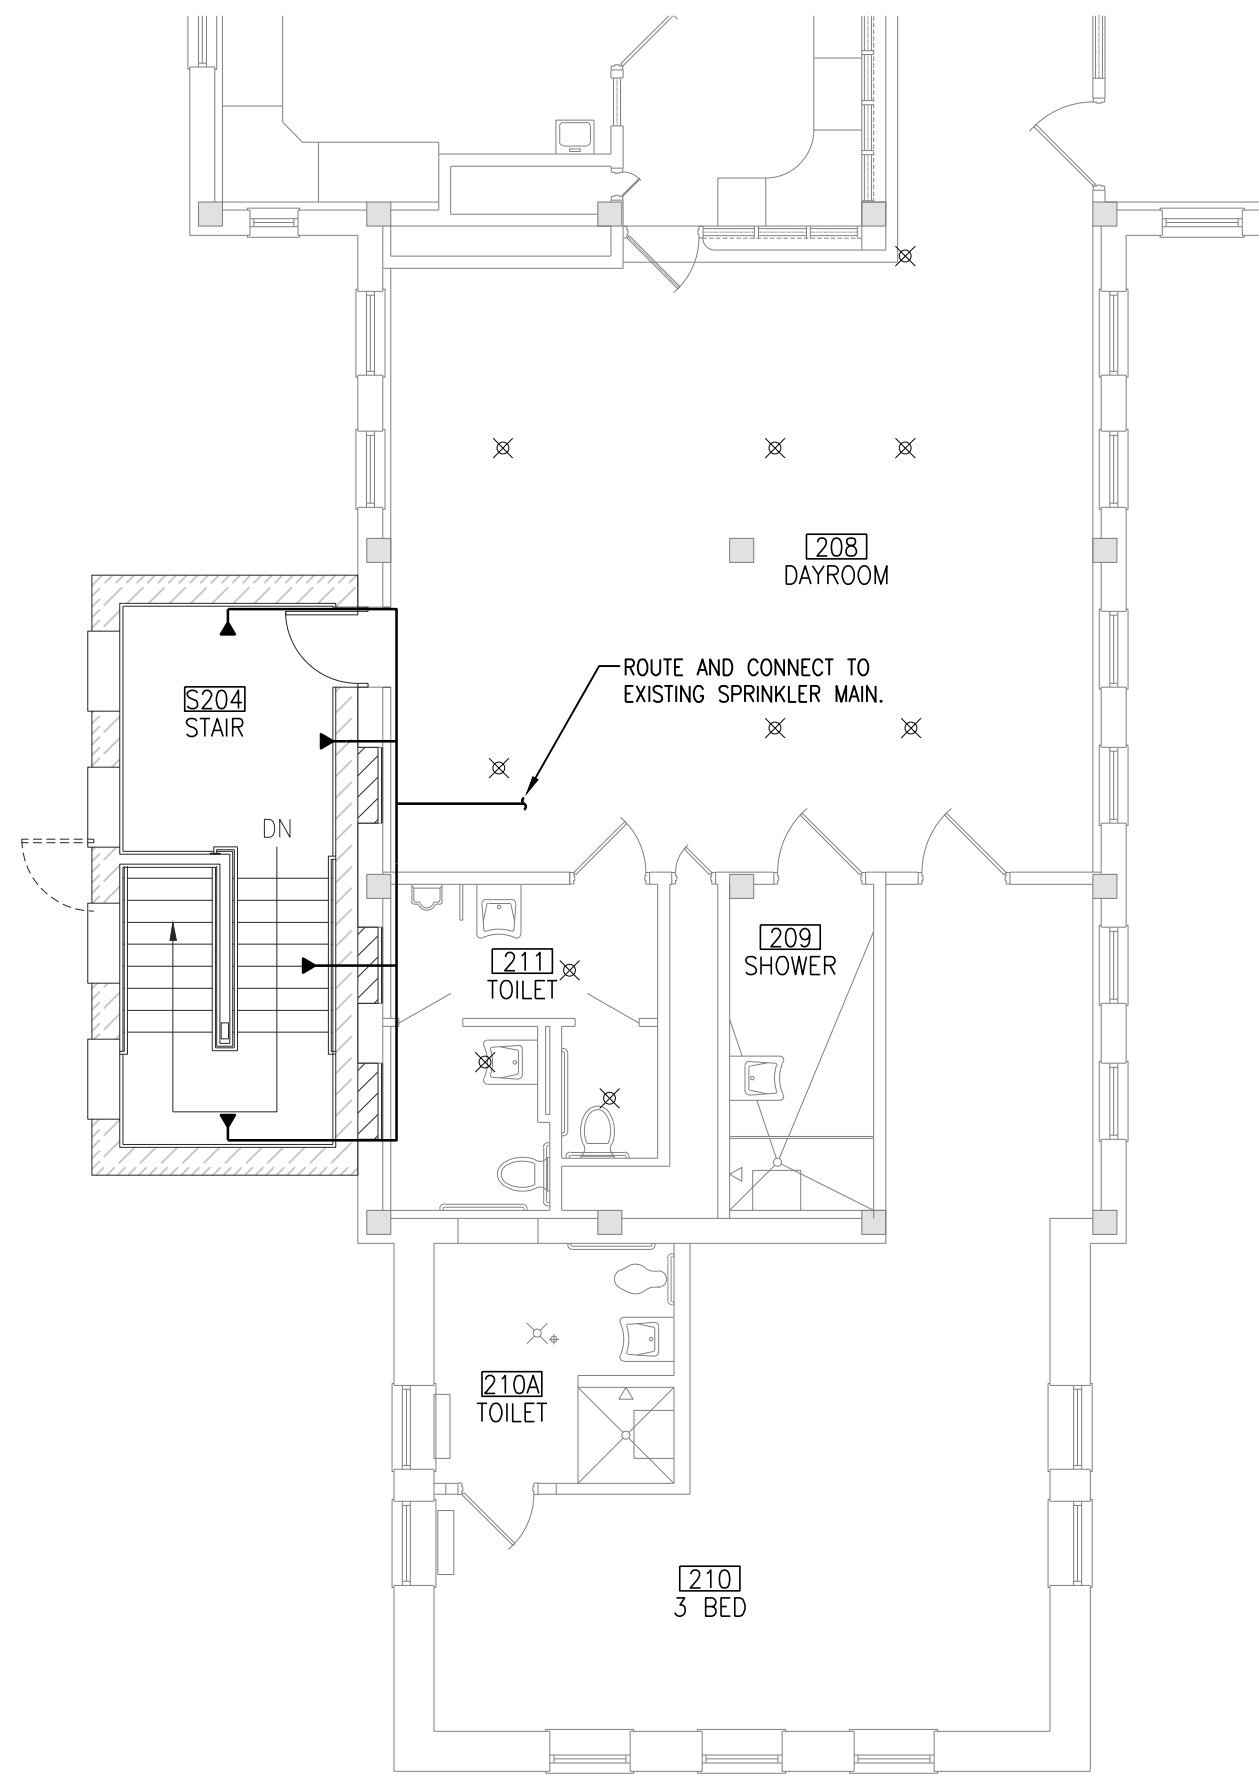

SECOND FLOOR FIRE PROTECTION REMODELING PLAN  
1/8"=1'-0"

- SPRINKLER HEAD LEGEND**
- CHROME PLATED RECESSED TYPE SPRINKLER HEAD
  - BRASS UPRIGHT PENDENT TYPE SPRINKLER HEAD
  - BRASS PENDENT TYPE SPRINKLER HEAD
  - WHITE CONCEALED PENDENT TYPE SPRINKLER HEAD
  - SIDEWALL PENDENT TYPE SPRINKLER HEAD
  - BRASS UPRIGHT SIDEWALL PENDENT TYPE SPRINKLER HEAD
- FIRE PROTECTION NOTES:**
- CONTRACTOR SHALL VERIFY ALL EXISTING CONDITIONS PRIOR TO BEGINNING WORK AND NOTIFY THE ARCHITECT/ ENGINEER OF ANY DISCREPANCIES BETWEEN THE "AS-BUILT" CONDITIONS AND THESE DRAWINGS.
  - COORDINATE ALL FIRE PROTECTION INSTALLATION WITH GENERAL, PLUMBING, VENTILATION, AND ELECTRICAL CONTRACTORS. INSTALL ALL FIRE PROTECTION PIPING AS HIGH AS POSSIBLE. PROVIDE ALL NECESSARY OFFSETS (DROPS AND RISES) TO KEEP FIRE PROTECTION PIPING TIGHT TO THE STRUCTURE OR DUCTWORK ABOVE. OFFSET FIRE PROTECTION PIPING TO AVOID DEANS AND INSTALLATION BY ALL TRADES.
  - ALL FIRE PROTECTION WORK SHALL ADHERE TO CURRENT NFPA 13 STANDARDS.
  - ENTIRE BUILDING SHALL BE SPRINKLED. VERIFY WHERE MULTIPLE FLOORS EXIST.
  - FIRE PROTECTION PIPING AND SPRINKLER HEADS ARE SHOWN FOR REFERENCE ONLY.
  - SPRINKLER HEADS IN LAY-IN-TILE CEILINGS SHALL BE LOCATED IN THE CENTER OF TILE.
  - REFER TO AND COORDINATE WITH THE ARCHITECTURAL PLANS FOR CEILING TYPES, HEIGHTS, SOFFIT AREAS, AND ELEVATIONS FOR INSTALLATION OF NEW FIRE PROTECTION PIPING, SPRINKLER HEADS, EQUIPMENT, ETC.
  - THIS CONTRACTOR IS RESPONSIBLE FOR REMOVAL AND RE-INSTALLING OF EXISTING CEILING TILE NOT REMOVED BY THE GENERAL CONTRACTOR FOR THE INSTALLATION OF NEW FIRE PROTECTION PIPING, SPRINKLER HEADS, EQUIPMENT, ETC. VERIFY WITH ARCHITECTURAL PLANS FOR CEILING WORK BY THE GENERAL CONTRACTOR. ANY CEILING TILE OR GRID DAMAGED DURING CONSTRUCTION SHALL BE REPLACED WITH NEW BY THIS CONTRACTOR.
  - THIS CONTRACTOR SHALL OPEN ALL EXISTING WALLS AND/OR CEILINGS FOR INSTALLATION OF NEW FIRE PROTECTION PIPING, SPRINKLER HEADS, EQUIPMENT, ETC. AS REQUIRED. PATCH WALLS AND/OR CEILINGS TO MATCH EXISTING.
  - MAINTAIN 3'-0" CLEAR SPACE IN FRONT OF ALL ELECTRICAL, CONTROL, AND ACCESS PANELS FOR ACCESSIBILITY.

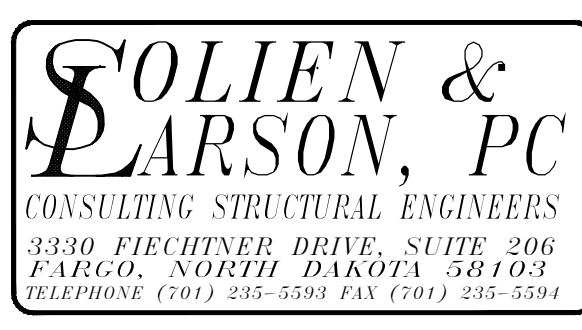

I hereby certify that this plan specification, or report was prepared by me or under my direct supervision, and that I am duly Registered Engineer under the laws of the State of Minnesota.

*Brent A. Wynn*


Date 02-21-2013 Reg. No. 42719


APPROVED: SERVICE LINE DIRECTOR	DATE:
APPROVED: SERVICE LINE DIRECTOR	DATE:
APPROVED: PROJECTS SECTION MANAGER	DATE:
APPROVED: DIRECTOR FMS	DATE:

APPROVED: INFECTION CONTROL NURSE	DATE:
APPROVED: PATIENT SAFETY	DATE:
APPROVED: CHIEF OF POLICE	DATE:
APPROVED: SAFETY MANAGER	DATE:


DRAWING FILE	DATE:
FIRE PROTECTION DEMOLITION AND REMODELING PLANS	DATE:
APPROVED: CHIEF OF STAFF	DATE:
APPROVED: MEDICAL CENTER DIRECTOR	DATE:

PROJECT FILE	DATE:
BUILDING 28 SOUTHWEST STAIR TOWER ADDITION	DATE:
BUILDING No.	CHECKED BY
28	BW
DATE:	DATE:
2012194	2012194-FPI.DWG
LOCATION	DRAWING NO.
VIA MEDICAL CENTER ST. CLOUD, MN 56203	FPI DWG 9 OF 13

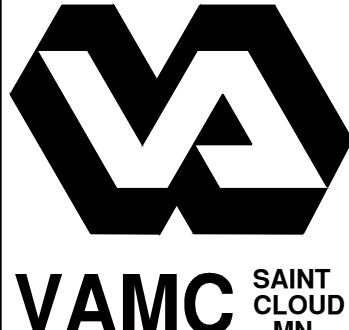


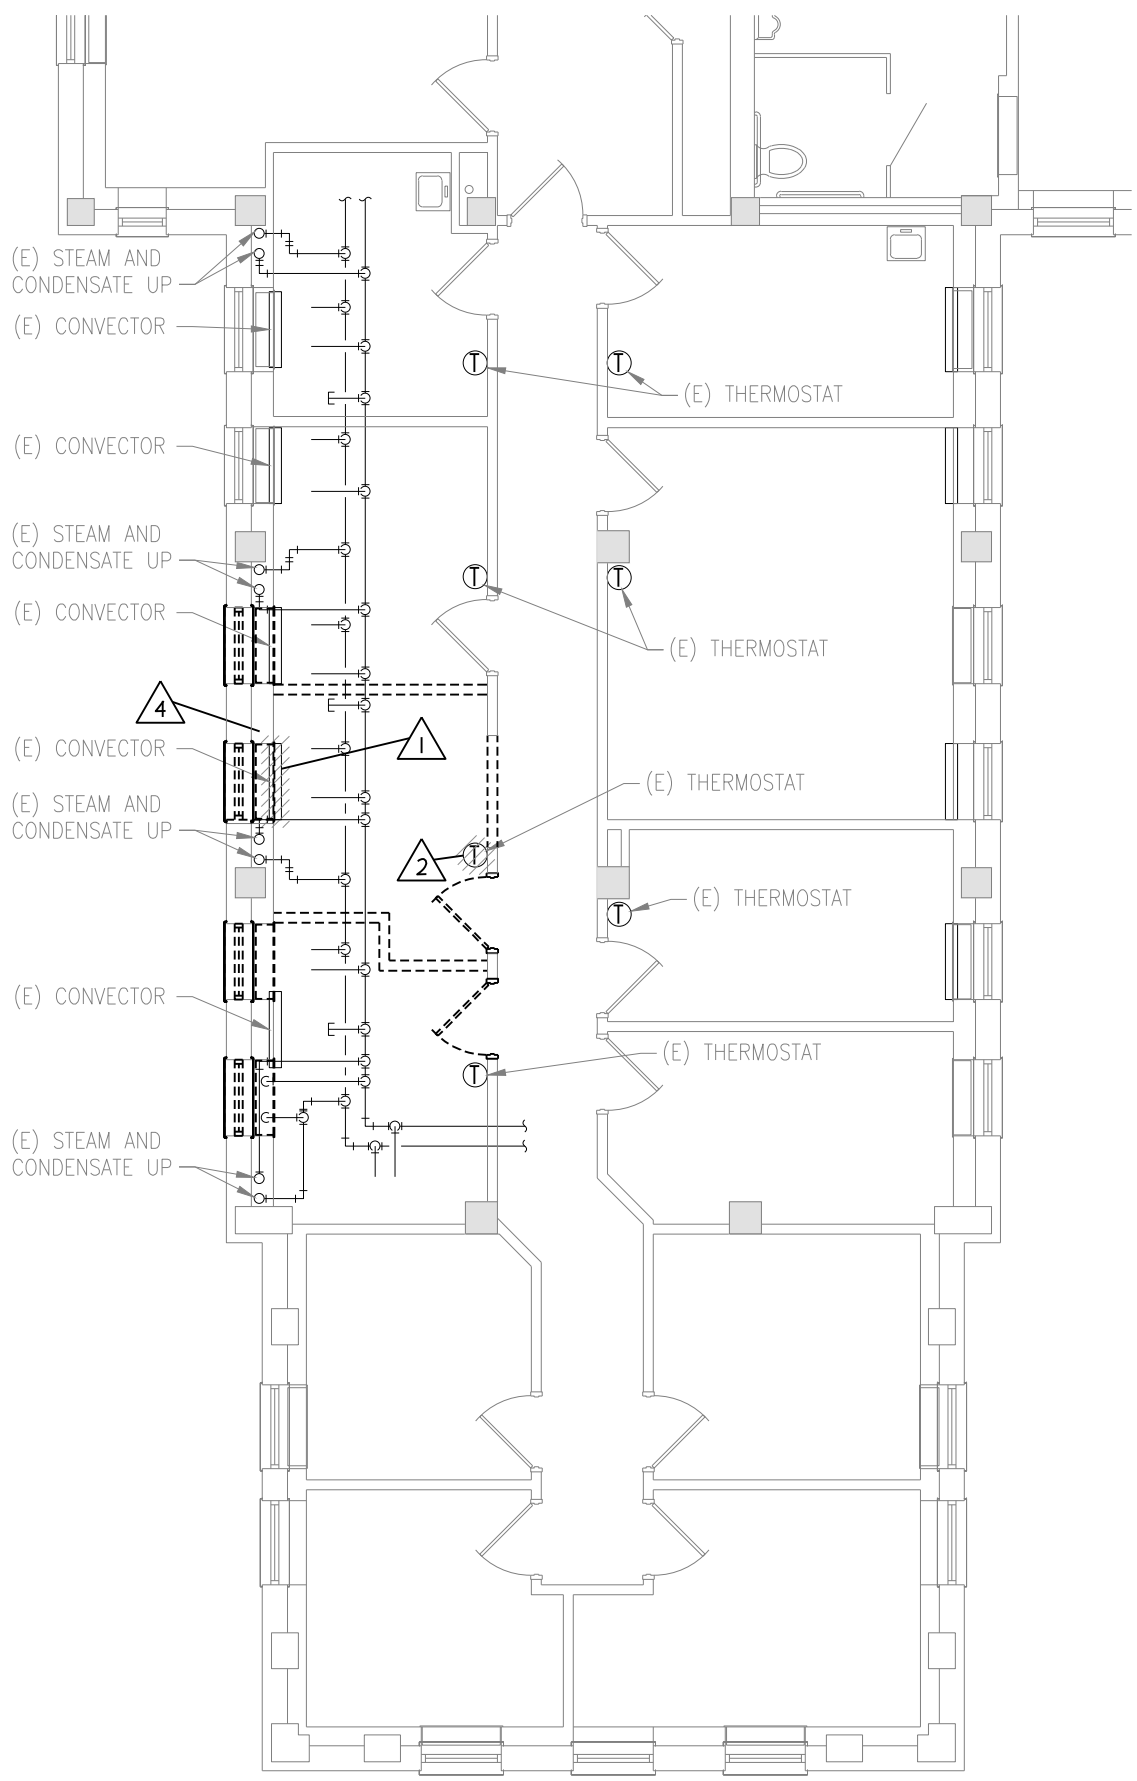

BASEMENT HVAC PIPING DEMOLITION PLAN  
1/8"=1'-0"

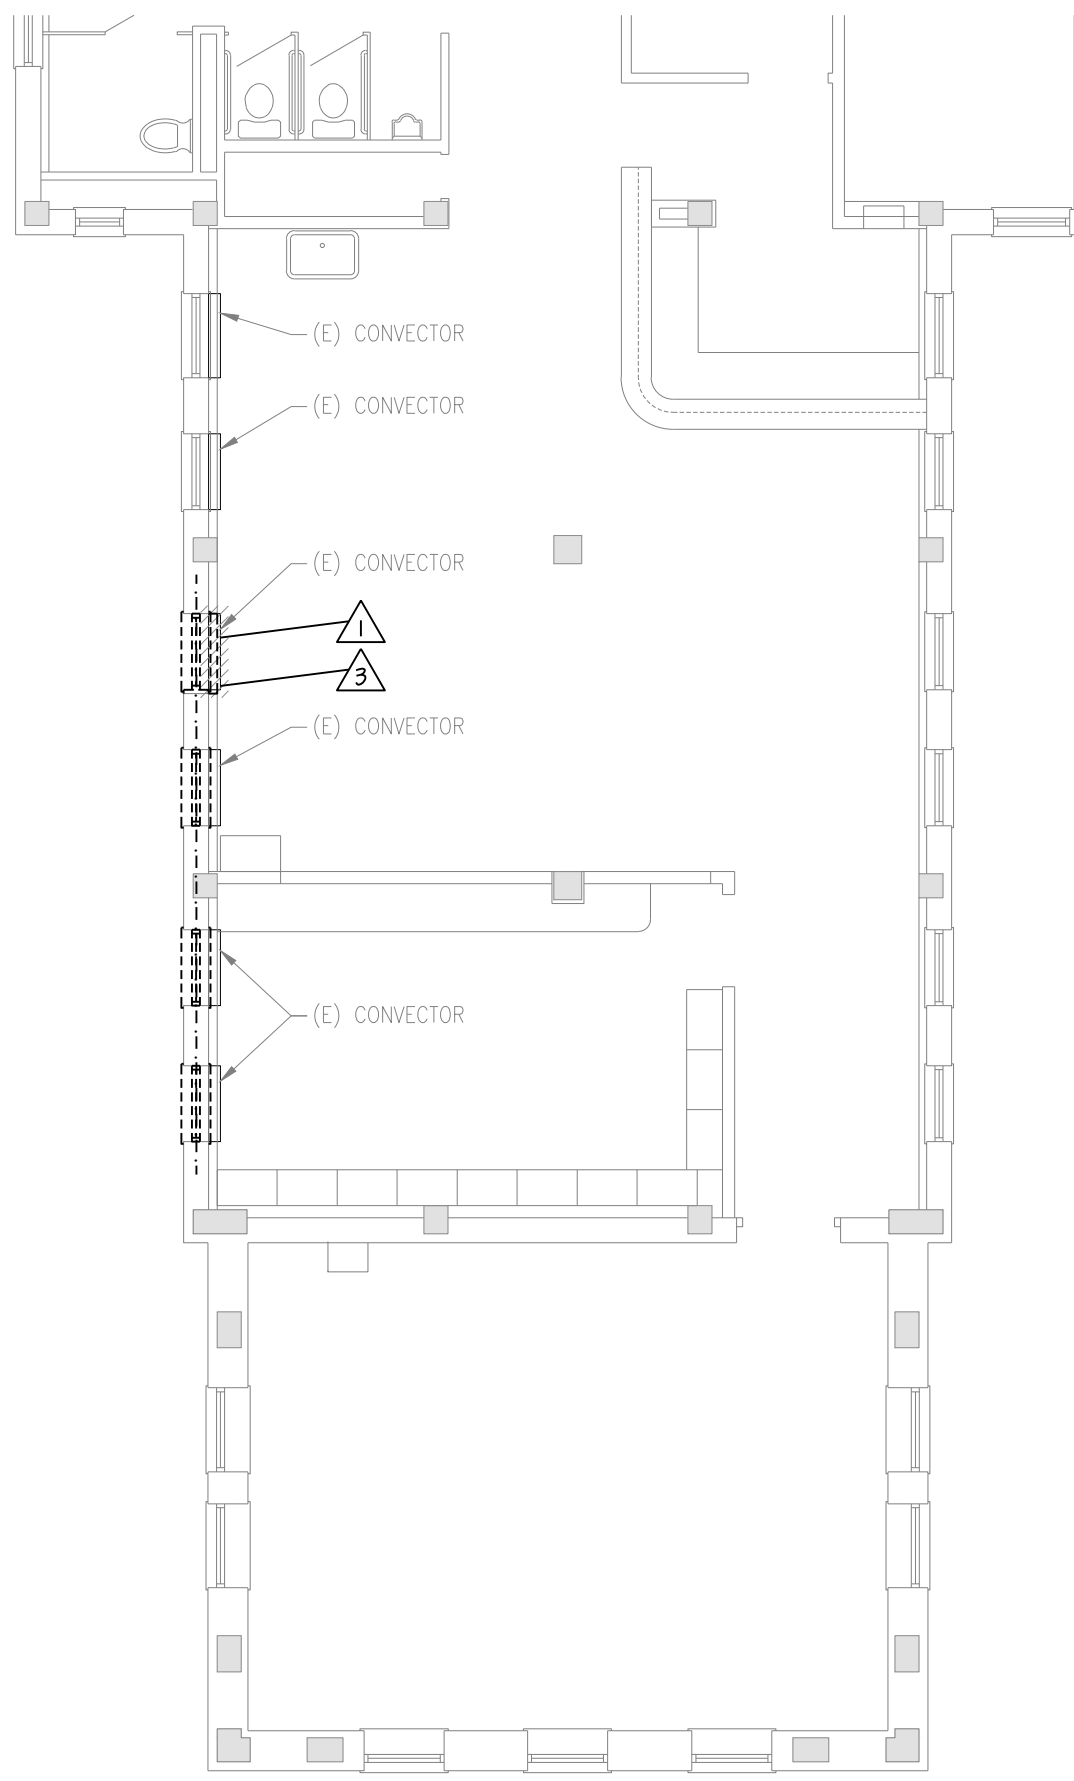


FIRST FLOOR HVAC PIPING DEMOLITION PLAN  
1/8"=1'-0"

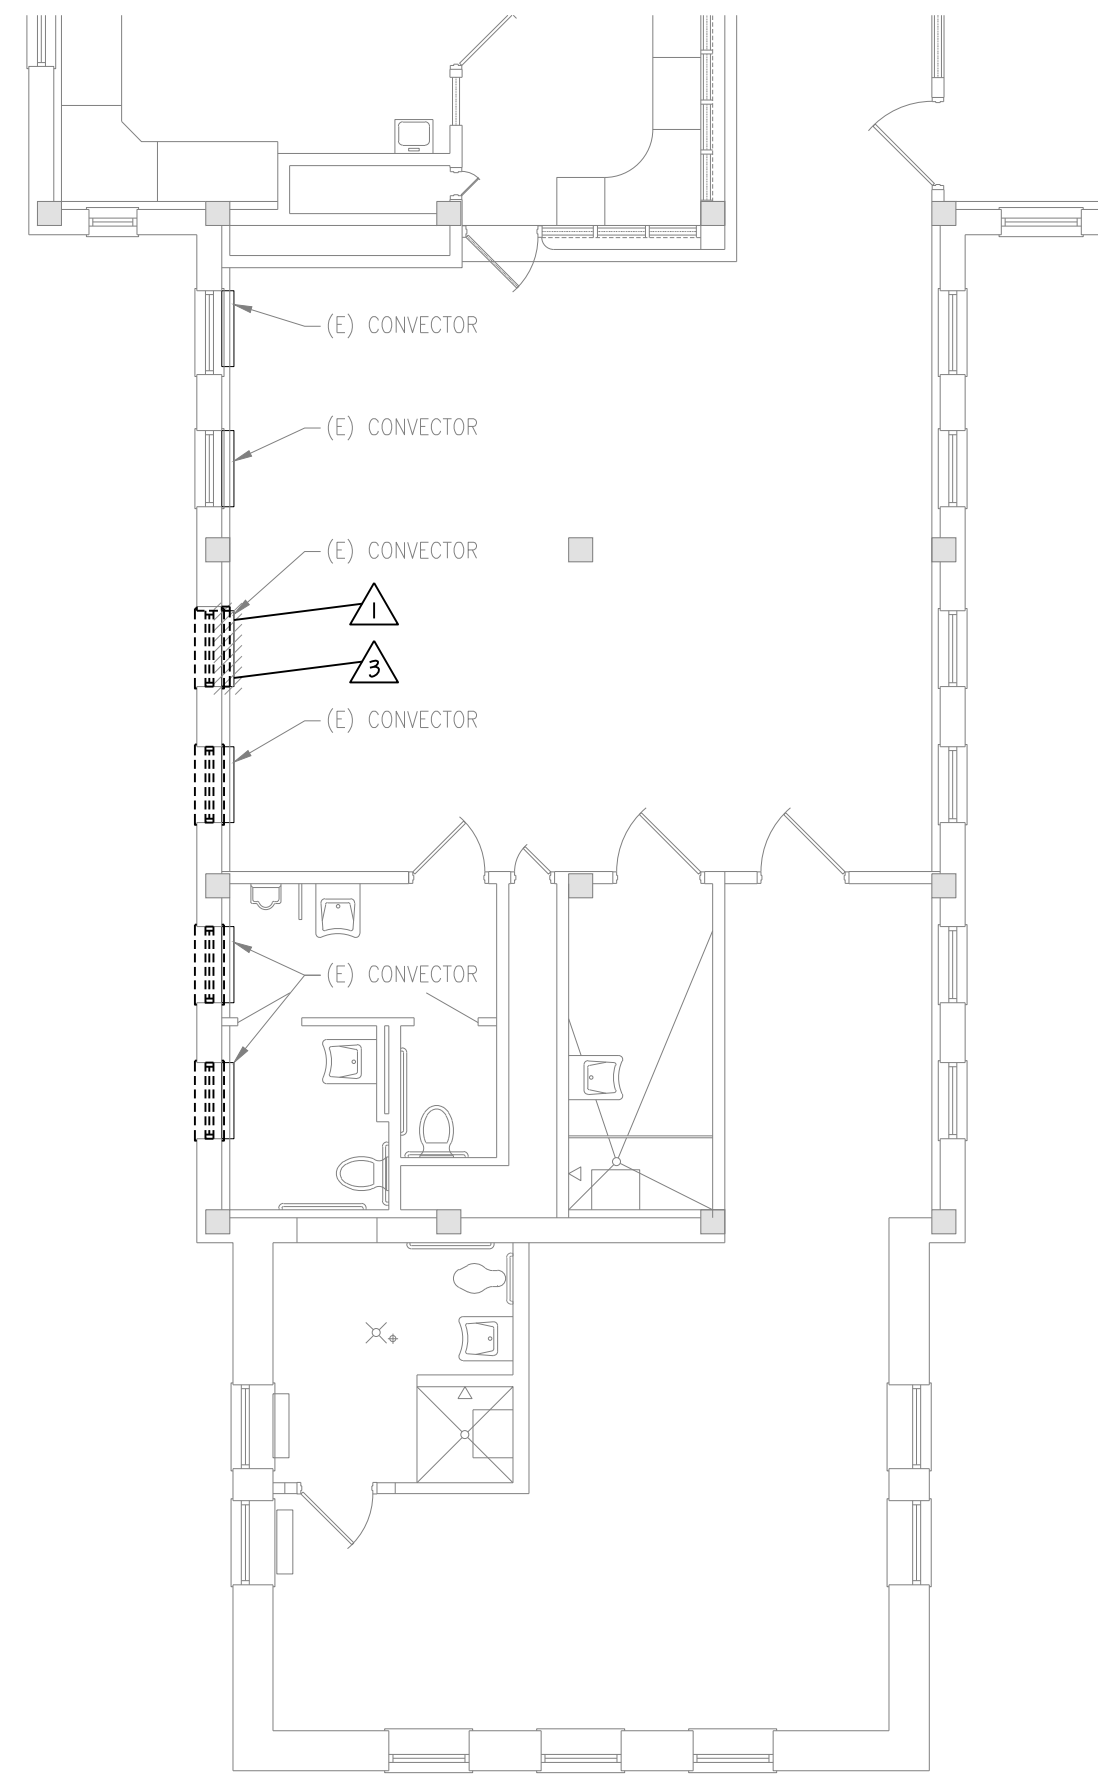

SECOND FLOOR HVAC PIPING DEMOLITION PLAN  
1/8"=1'-0"


- HVAC PIPING DEMOLITION NOTES:**
- DEMOLITION DRAWINGS ARE DIAGNOMATIC ONLY AND ARE BASED ON FIELD OBSERVATION AND EXISTING RECORD DRAWINGS. CONTRACTOR SHALL VERIFY ALL EXISTING CONDITIONS PRIOR TO BEGINNING WORK AND NOTIFY THE ARCHITECT/ ENGINEER OF ANY DISCREPANCIES BETWEEN THE "AS-BUILT" CONDITIONS AND THESE DRAWINGS. PROVIDE ADDITIONAL DEMOLITION AS REQUIRED BASED ON FIELD CONDITIONS.
  - THIS CONTRACTOR IS RESPONSIBLE FOR REMOVAL AND RE-INSTALLING OF EXISTING CEILING TILE NOT REMOVED BY THE GENERAL CONTRACTOR FOR THE DEMOLITION OF EXISTING HVAC PIPING, EQUIPMENT, ETC. VERIFY WITH ARCHITECTURAL PLANS FOR CEILING WORK BY THE GENERAL CONTRACTOR. ANY CEILING TILE OR GRID DAMAGED DURING CONSTRUCTION SHALL BE REPLACED WITH NEW BY THIS CONTRACTOR.
  - THIS CONTRACTOR SHALL OPEN ALL WALLS AND/OR CEILINGS FOR DEMOLITION OF EXISTING HVAC PIPING, EQUIPMENT, ETC. AS REQUIRED.
  - THIS CONTRACTOR IS RESPONSIBLE FOR PATCHING ALL HOLES/WALLS AND OR CEILINGS FROM DEMOLISHED HVAC PIPING, EQUIPMENT, ETC. IN FLOORS, WALLS, AND CEILINGS TO MATCH EXISTING.
- ⚠️ DISCONNECT AND REMOVE EXISTING CONVECTOR INCLUDING ALL ASSOCIATED CONTROLS, PIPING, VALVES, SUPPORTS, ETC. CAP REMAINING STEAM AND CONDENSATE PIPING AT MAIN.
- ⚠️ DISCONNECT AND REMOVE EXISTING THERMOSTAT INCLUDING ALL ASSOCIATED TUBING / WIRING.
- ⚠️ DOCUMENT EXISTING PIPING CONDITIONS IN THE WALL DURING DEMOLITION. RELOCATE EXISTING STEAM AND CONDENSATE PIPING TO THE FLOOR BELOW AND BACK UP AS REQUIRED FOR NEW STAIR DOOR. REMOVE AND REPLACE EXISTING CEILINGS AND REMOVE AND PATCH EXISTING WALLS AS REQUIRED FOR REDROUTING PIPING.
- ⚠️ DISCONNECT AND REMOVE EXISTING STEAM AND CONDENSATE PIPING IN WALL FROM EXISTING CONVECTOR. PREPARE PIPING FOR RE-CONNECTION.

HOT WATER UNIT HEATER SCHEDULE									
UNIT NO.	LOCATION	TYPE UNIT	CFM	MIN. BTUH	LBS HR	MAX P.D.	HP	MOTOR	
CUH-1	STAIRWELL	CUH	335	20.5	20	-	1/15	VOLT-PHASE	120/1
CUH CABINET UNIT HEATER 1. INVERTED FLOW UNIT. 15750									

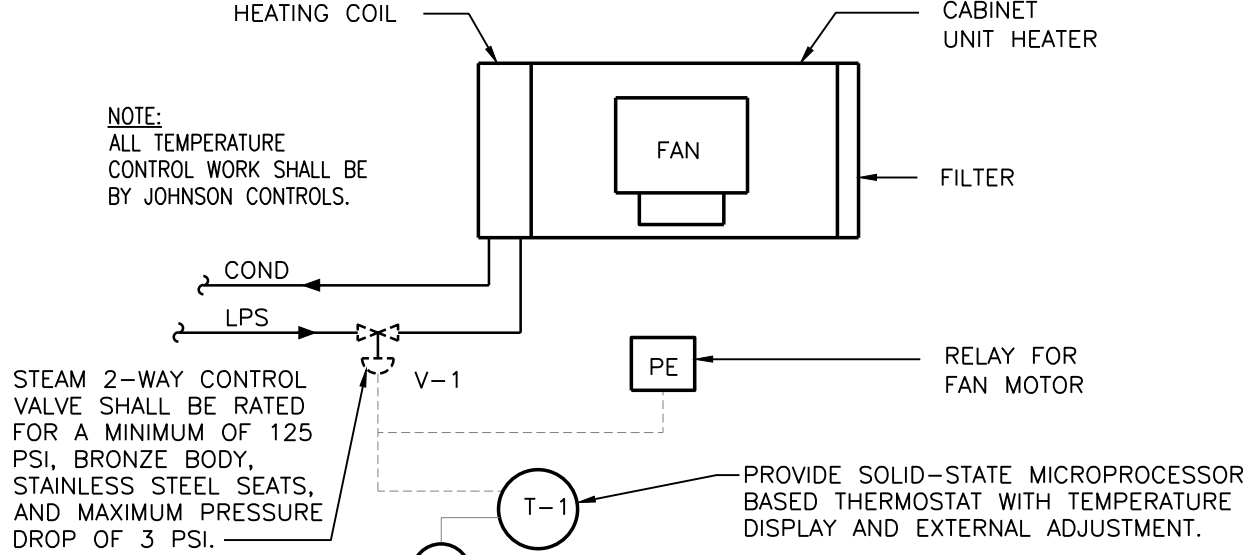


ROOM THERMOSTAT T-1 SHALL CONTROL ELECTRONIC-RELAY FOR FAN MOTOR AND HEATING COIL VALVE V-1 IN SEQUENCE. ON A DROP IN TEMPERATURE TO THE SET POINT OF ROOM THERMOSTAT T-1, THRU ELECTRONIC-ELECTRIC RELAY, SHALL START THE FAN. HEATING COIL VALVE V-1 SHALL REMAIN OFF. ON A DROP IN TEMPERATURE SLIGHTLY BELOW THE SET POINT T-1 SHALL MODULATE HEATING COIL VALVE V-1. FAN SHALL REMAIN ON.


**STEAM CABINET UNIT  
HEATER CONTROL DIAGRAM**  
NO SCALE

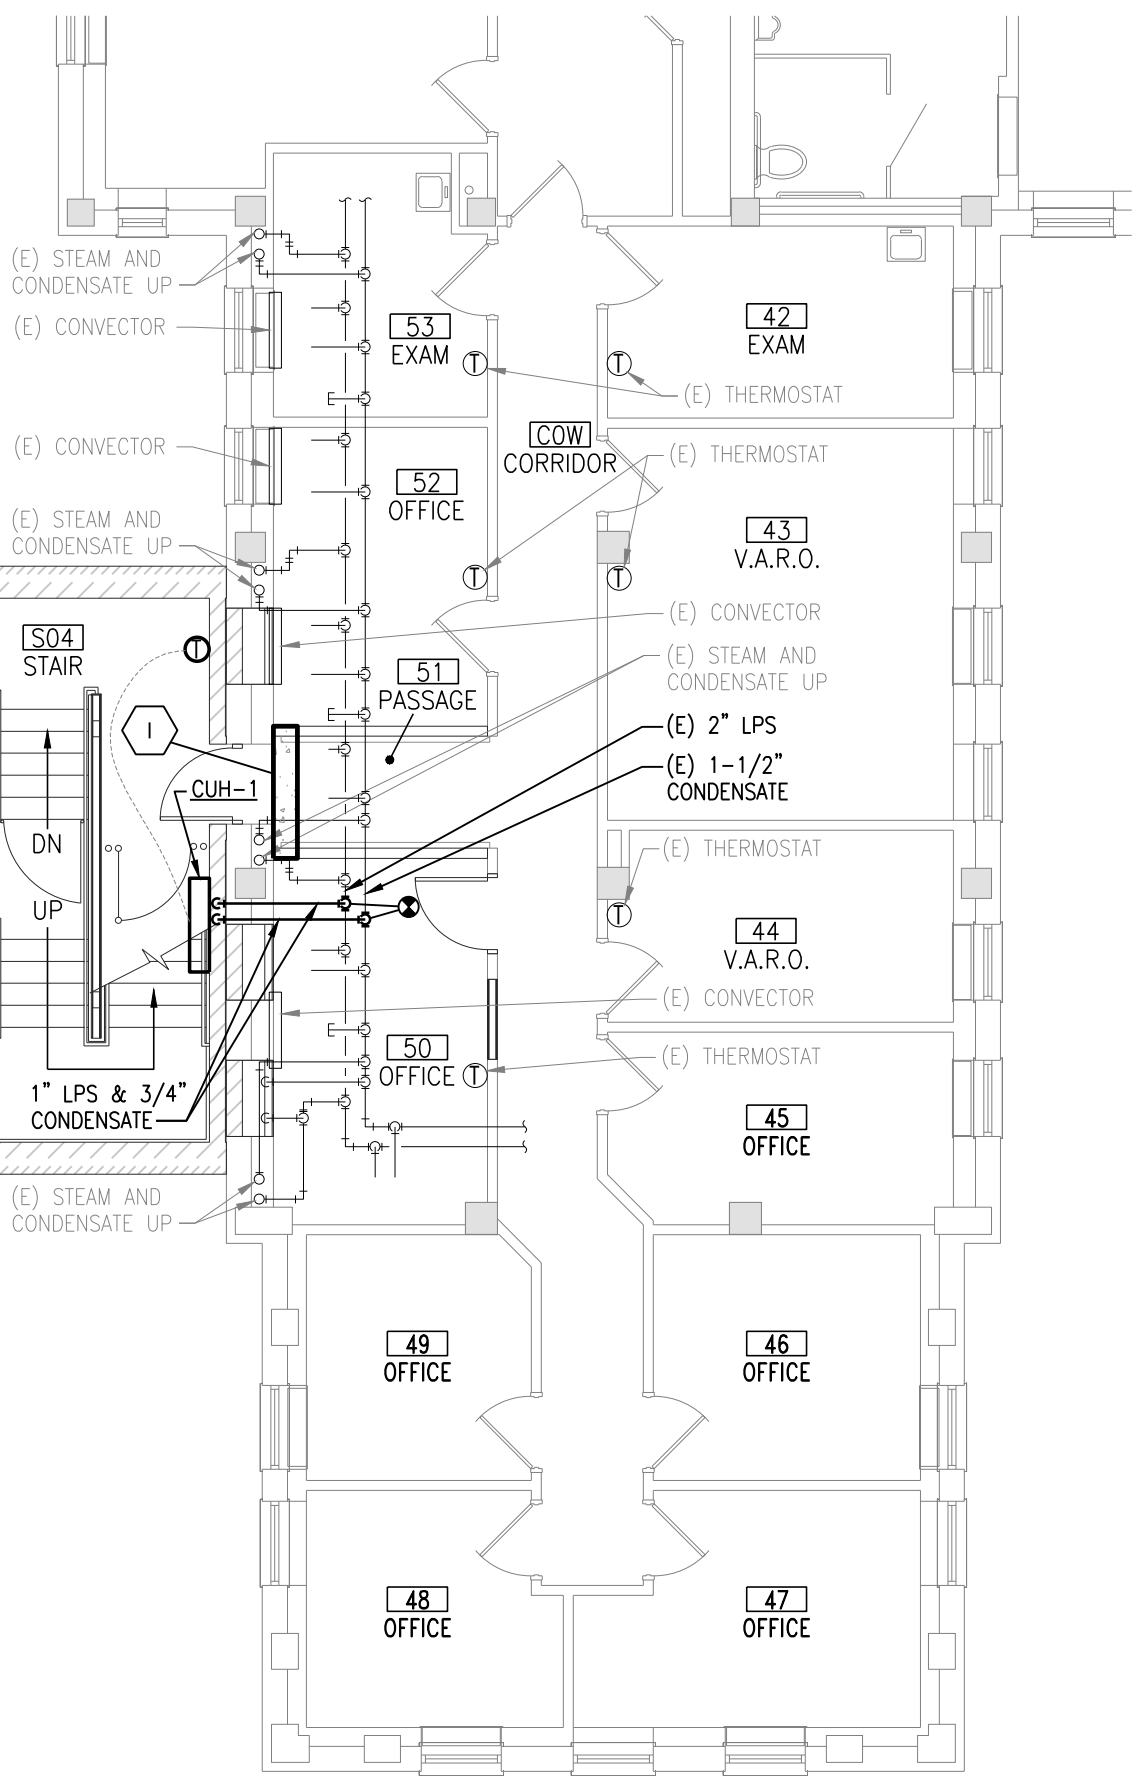

BASEMENT HVAC PIPING REMODELING PLAN  
1/8"=1'-0"

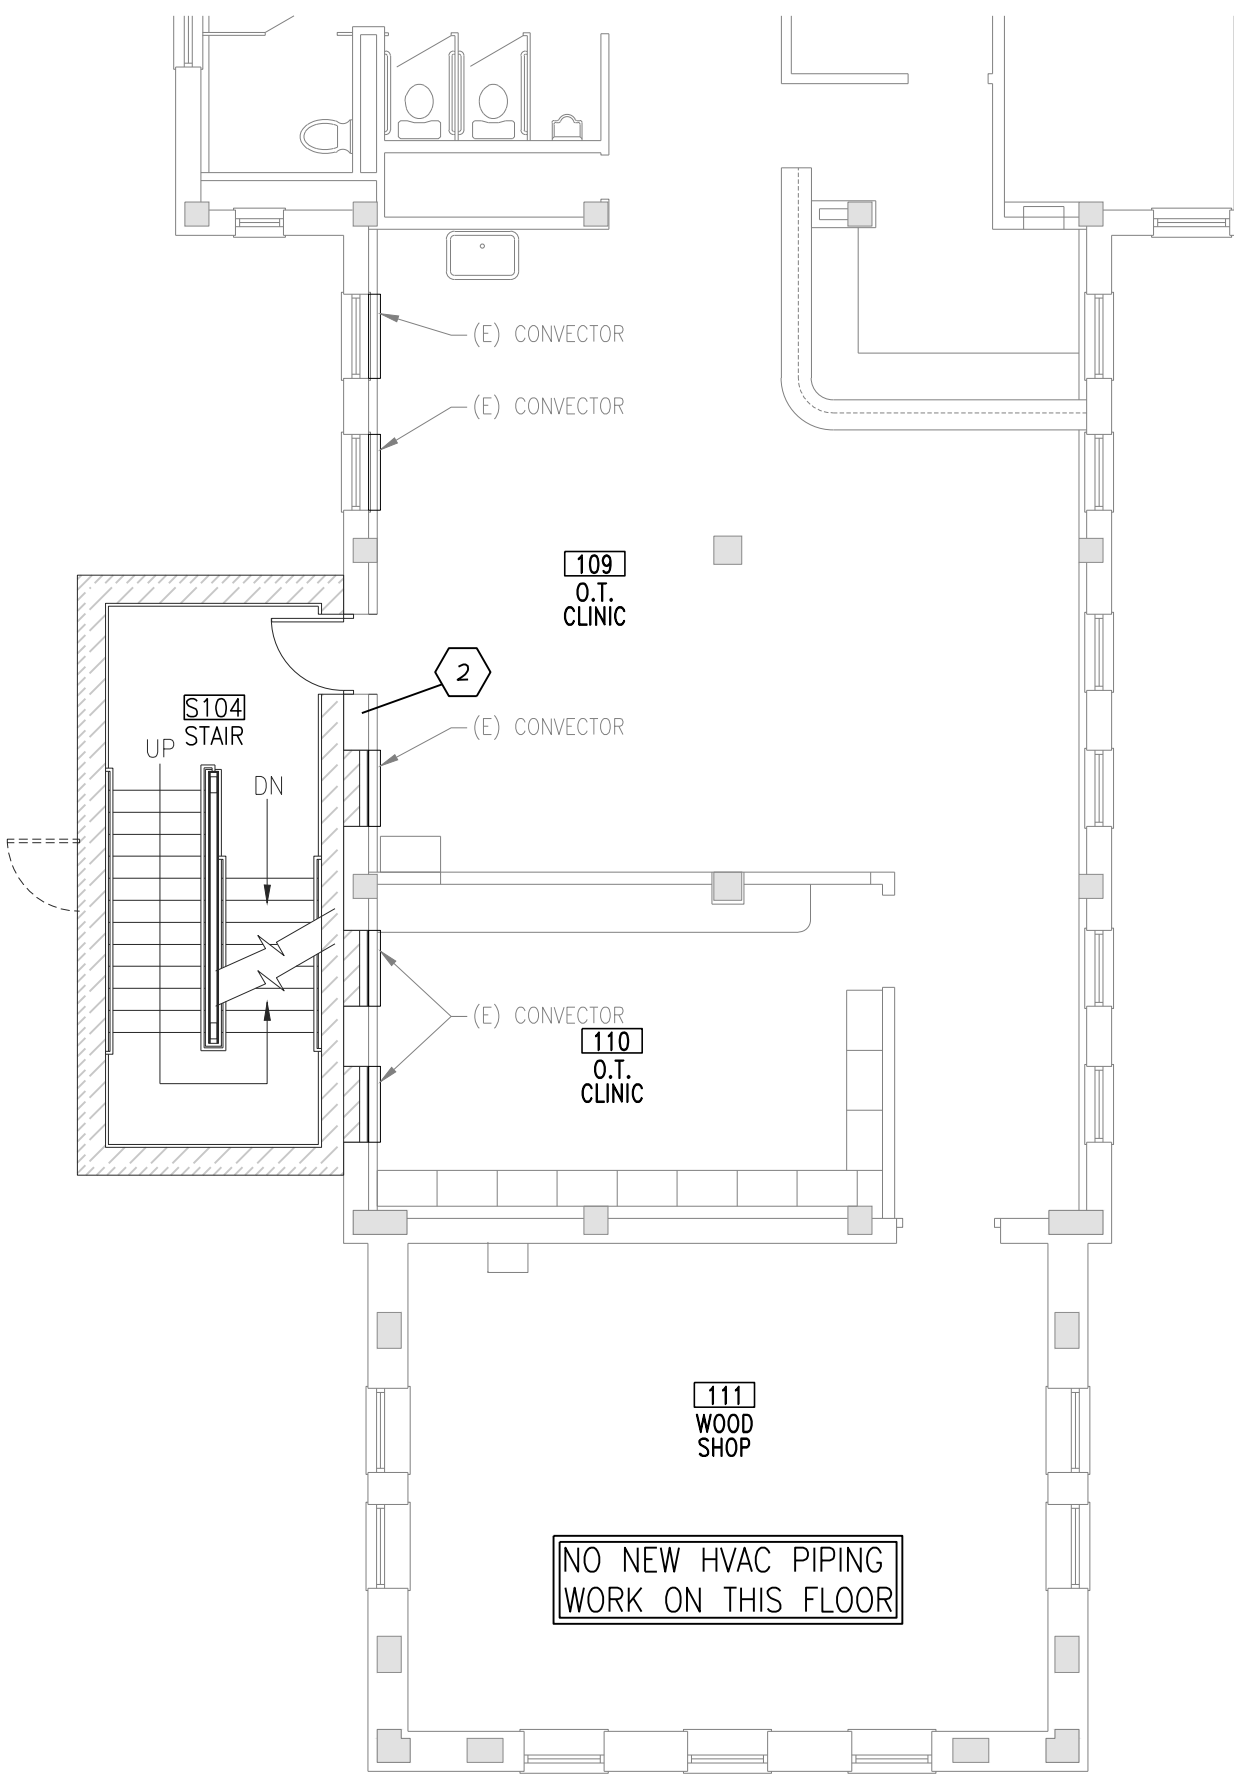

FIRST FLOOR HVAC PIPING REMODELING PLAN  
1/8"=1'-0"

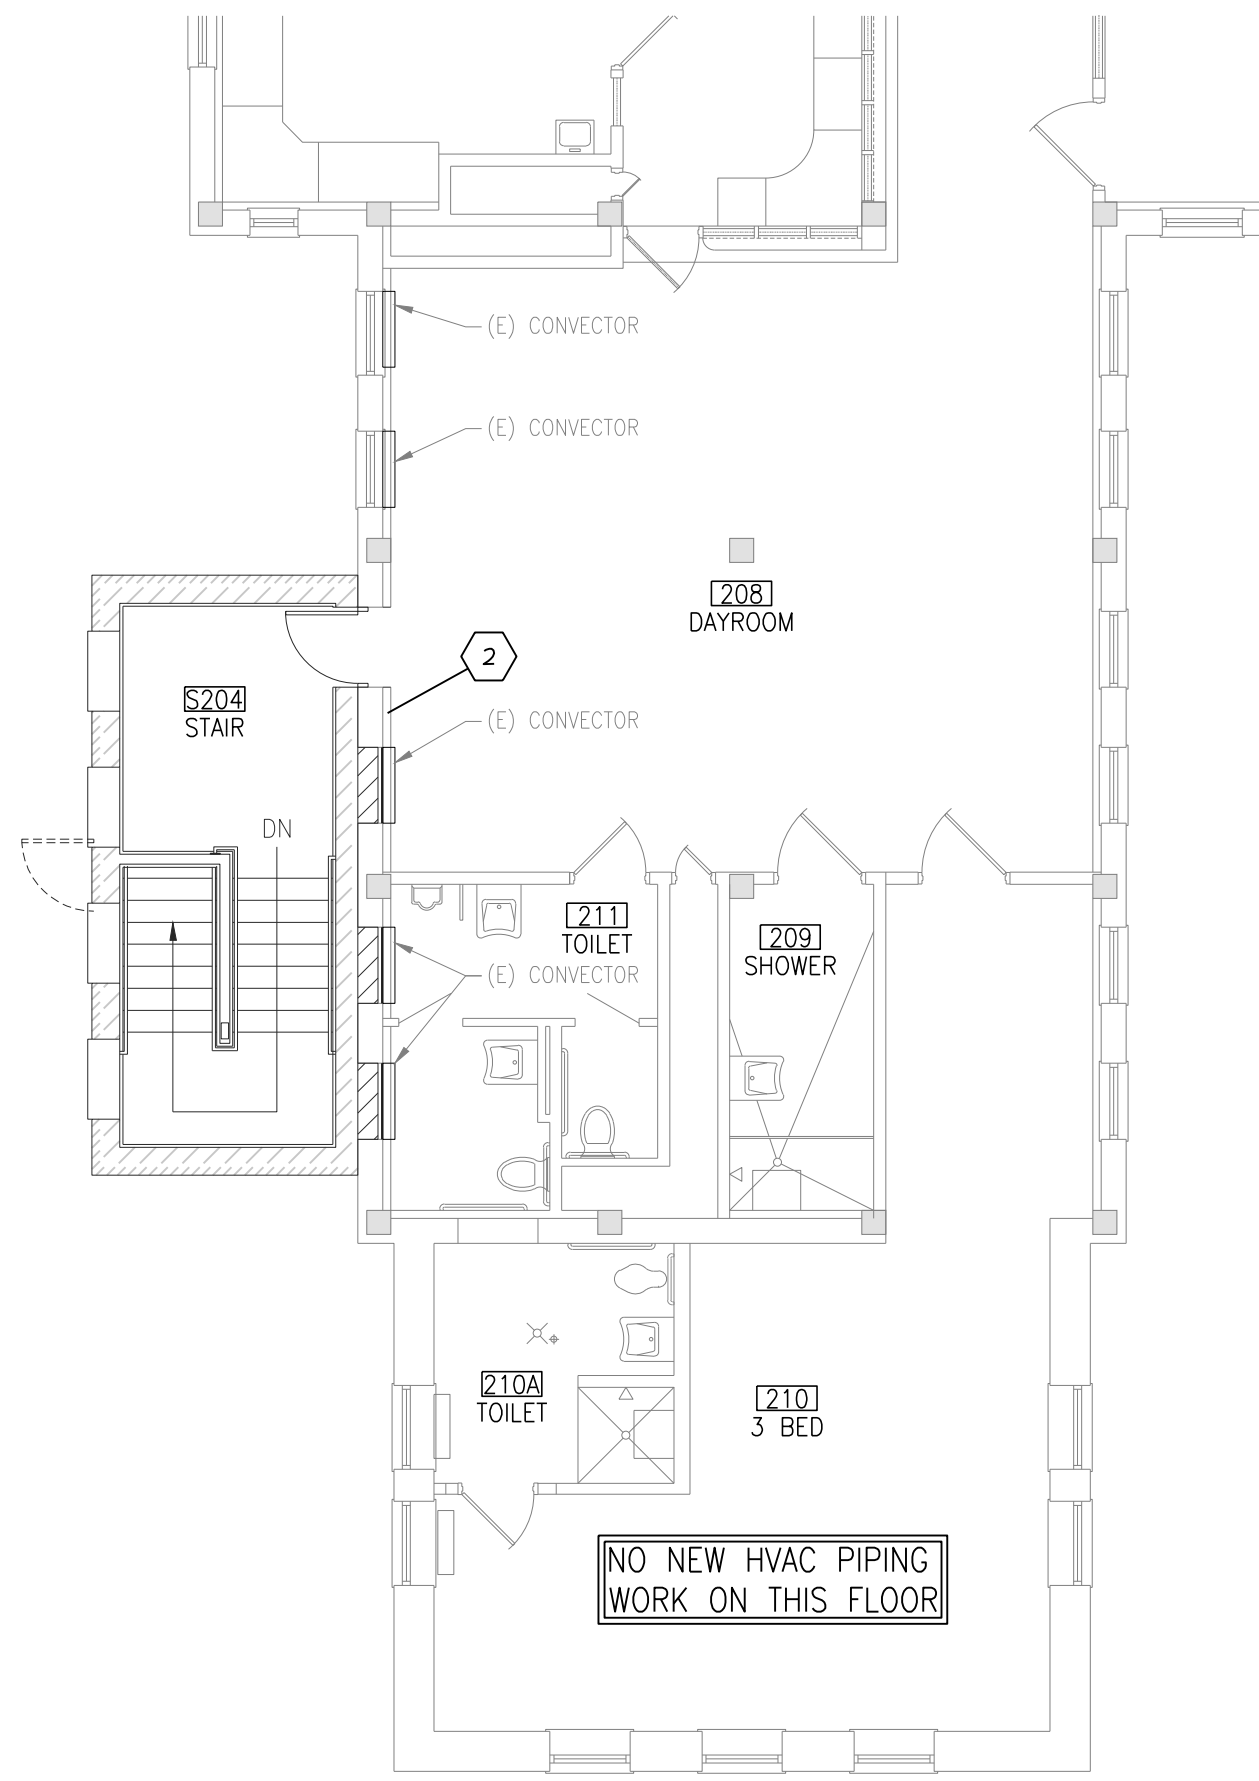

SECOND FLOOR HVAC PIPING REMODELING PLAN  
1/8"=1'-0"

- HVAC PIPING NOTES:**
- CONTRACTOR SHALL VERIFY ALL EXISTING CONDITIONS PRIOR TO BEGINNING WORK AND NOTIFY THE ARCHITECT/ ENGINEER OF ANY DISCREPANCIES BETWEEN THE "AS-BUILT" CONDITIONS AND THESE DRAWINGS.
  - COORDINATE ALL HVAC PIPING INSTALLATION WITH GENERAL PLUMBING, FIRE PROTECTION, VENTILATION, AND ELECTRICAL CONTRACTORS. INSTALL ALL HVAC PIPING AS HIGH AS POSSIBLE. PROVIDE ALL NECESSARY OFFSETS (DROPS AND RISERS) TO KEEP HVAC PIPING TIGHT TO THE STRUCTURE OR DUCTWORK ABOVE. OFFSET HVAC PIPING TO AVOID BEAMS AND INSTALLATION BY ALL TRADES.
  - REFER TO AND COORDINATE WITH THE ARCHITECTURAL PLANS FOR CEILING TYPES, HEIGHTS, SOFFIT AREAS, AND ELEVATIONS FOR INSTALLATION OF NEW HVAC PIPING, EQUIPMENT, ETC.
  - THIS CONTRACTOR IS RESPONSIBLE FOR REMOVAL AND RE-INSTALLING OF EXISTING CEILING TILE NOT REMOVED BY THE GENERAL CONTRACTOR FOR THE INSTALLATION OF NEW HVAC PIPING, EQUIPMENT, ETC. VERIFY WITH ARCHITECTURAL PLANS FOR CEILING WORK BY THE GENERAL CONTRACTOR. ANY CEILING TILE OR GRID DAMAGED DURING CONSTRUCTION SHALL BE REPLACED WITH NEW BY THIS CONTRACTOR.
  - THIS CONTRACTOR SHALL OPEN ALL EXISTING WALLS AND/OR CEILINGS TO INSTALL NEW HVAC PIPING, EQUIPMENT, ETC. AS REQUIRED. PATCH WALLS AND/OR CEILINGS TO MATCH EXISTING.
  - MAINTAIN 3'-0" CLEAR SPACE IN FRONT OF ALL ELECTRICAL, CONTROL, AND ACCESS PANELS FOR ACCESSIBILITY.
  - ALL SHUT-OFF VALVES, CONTROL VALVES, STRAINERS, ETC. SHALL BE INSTALLED IN ACCESSIBLE CEILINGS. VALVES SHALL BE LOCATED NOT MORE THAN 2 FEET ABOVE ACoustICAL CEILINGS.
  - SHUT-OFF VALVES FOR ALL TERMINAL DEVICES SHALL BE AS ACCESSIBLE AS POSSIBLE TO THE CONTROLLED DEVICE.
  - PROVIDE 1/2" DRAIN VALVE AT ALL LOW POINTS OF EACH SYSTEM TO ENABLE COMPLETE DRAINAGE. PROVIDE 1/2" VENT VALVES AT ALL HIGH POINTS OF EACH SYSTEM TO ENABLE COMPLETE VENTING.
1. CONNECT TO EXISTING STEAM AND CONDENSATE PIPING IN WALL SERVING CONVECTORS. ROUTE NEW PIPING DOWN IN WALL. SAW CUT TRENCH INTO FLOOR AND ROUTE STEAM AND CONDENSATE PIPING BELOW FLOOR IN TRENCH IN AN APPROPRIATE SLEEVE. PATCH FLOOR TO MATCH EXISTING.
2. RELOCATE EXISTING STEAM AND CONDENSATE PIPING TO THE FLOOR BELOW AND BACK UP AS REQUIRED FOR NEW STAIR DOOR. REMOVE AND REPLACE EXISTING CEILINGS AND REMOVE AND PATCH EXISTING WALLS AS REQUIRED FOR REDROUTED PIPING.



I hereby certify that this plan specification, or report was prepared by me or under my direct supervision, and that I am duly Registered Engineer under the laws of the State of Minnesota.


*Brent A. Wynn*


Date 02-21-2013 Reg. No. 42719

APPROVED: SERVICE LINE DIRECTOR	DATE:	APPROVED: INFECTION CONTROL NURSE	DATE:
APPROVED: SERVICE LINE DIRECTOR	DATE:	APPROVED: PATIENT SAFETY	DATE:
APPROVED: PROJECTS SECTION MANAGER	DATE:	APPROVED: CHIEF OF POLICE	DATE:
APPROVED: DIRECTOR FMS	DATE:	APPROVED: SAFETY MANAGER	DATE:

DRAWING FILE	DRAWING NO.
HVAC PIPING, DEMOLITION AND REMODELING PLANS	2012194
APPROVED: CHIEF OF STAFF	DATE:
APPROVED: MEDICAL CENTER DIRECTOR	DATE:

PROJECT FILE	DATE
BUILDING 26 SOUTHWEST STAIR TOWER ADDITION	FEBRUARY 21, 2013
BUILDING NO.	CHECKED BY
26	BW
DRAWN	DATE
MW	2012194-H1.DWG
LOCATION	DRAWING NO.
VIA MEDICAL CENTER ST.CLOUD, MN 56203	H1
	DWG 1 OF 13

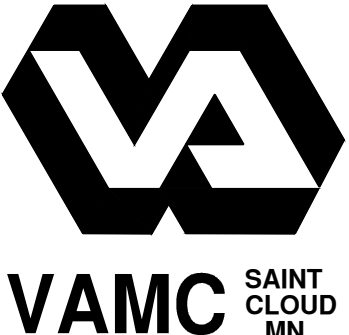

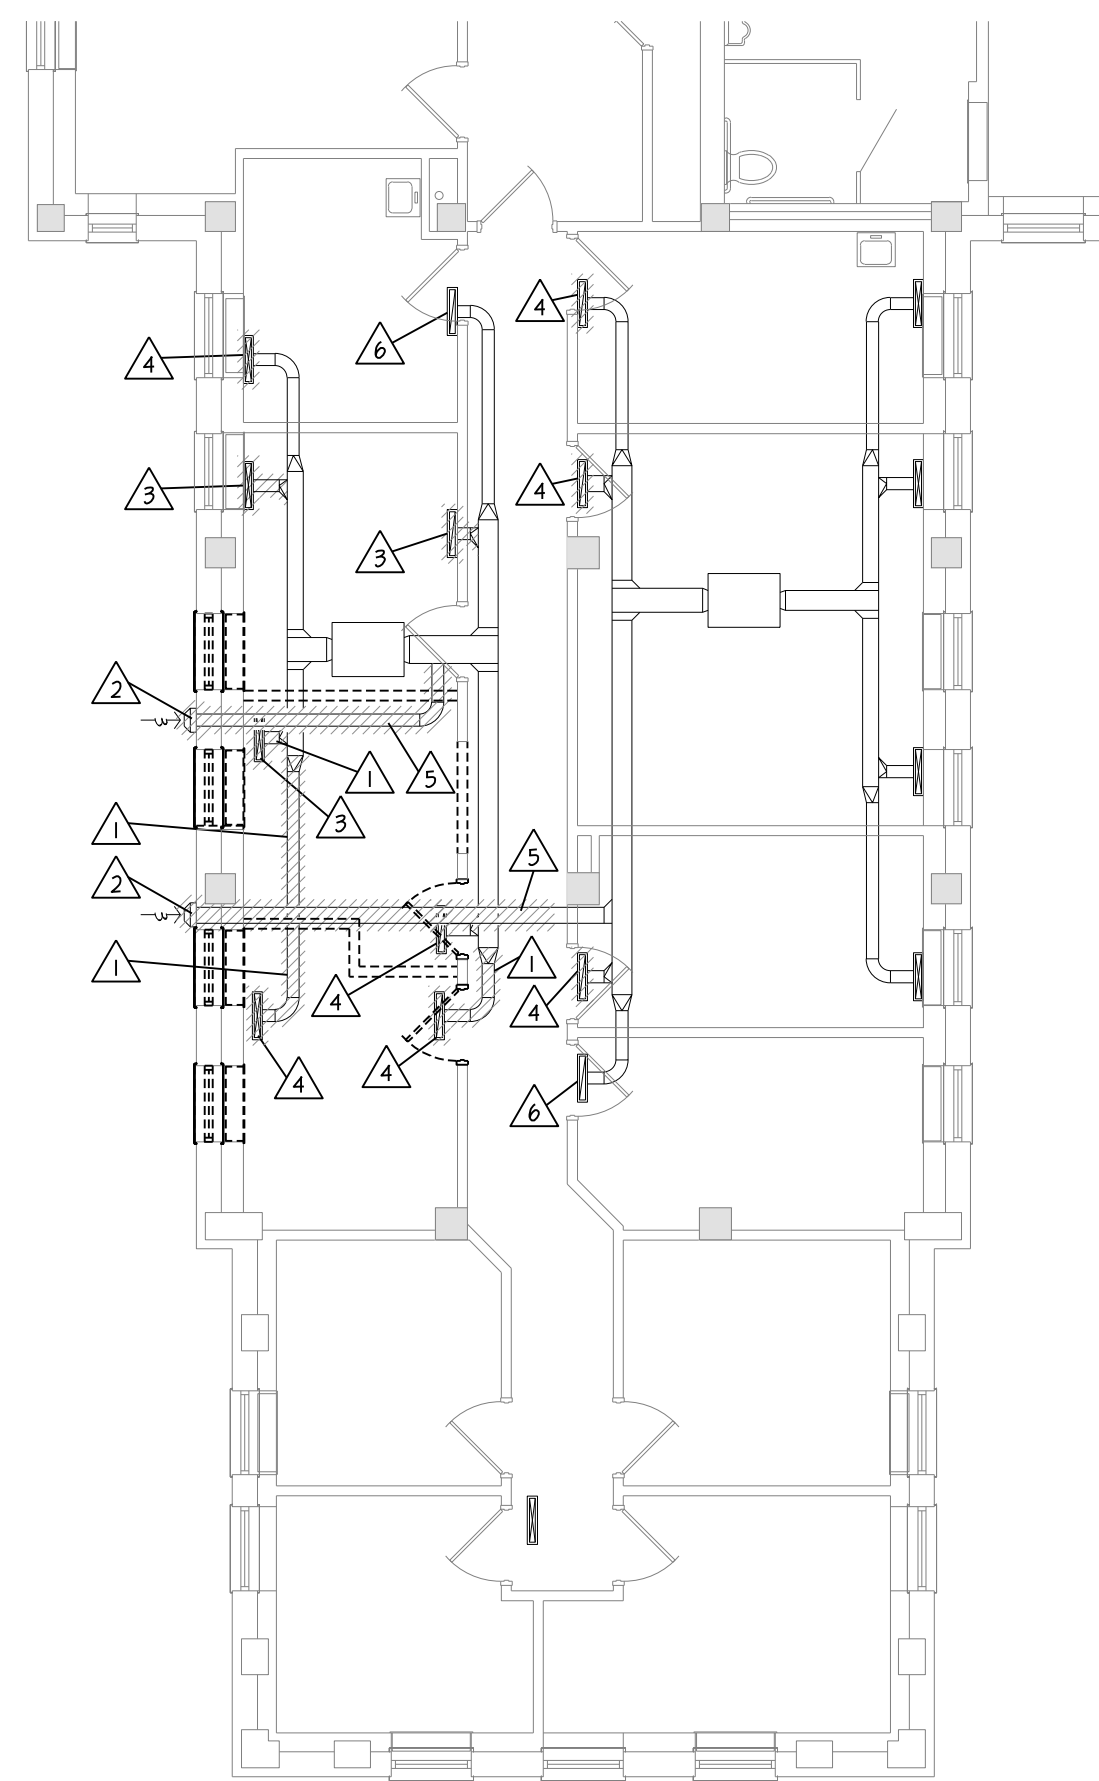


BASEMENT VENTILATION DEMOLITION PLAN  
1/8"=1'-0"

QNT NO.	MATERIAL	TYPE	NECK SIZE	FRAME SIZE	MOUNTING	AIR	QBD	REMARKS
S-1	STEEL	LSD	23"x3-5/8"	23"x4-1/2"	L.I.T.	SA	N	1
S-2	STEEL	LSD	23"x5-3/8"	23"x5-3/8"	L.I.T.	SA	N	2
R-1	STEEL	LSD	23"x3-5/8"	23"x4-1/2"	L.I.T.	RA	N	1
R-2	STEEL	LSD	23"x5-3/8"	23"x5-3/8"	L.I.T.	RA	N	2


LSD      LINEAR SLOT DIFFUSER      NOTES:

1. 2 SLOT, 1" SLOT SPACING DIFFUSER
2. 3 SLOT, 1" SLOT SPACING DIFFUSER


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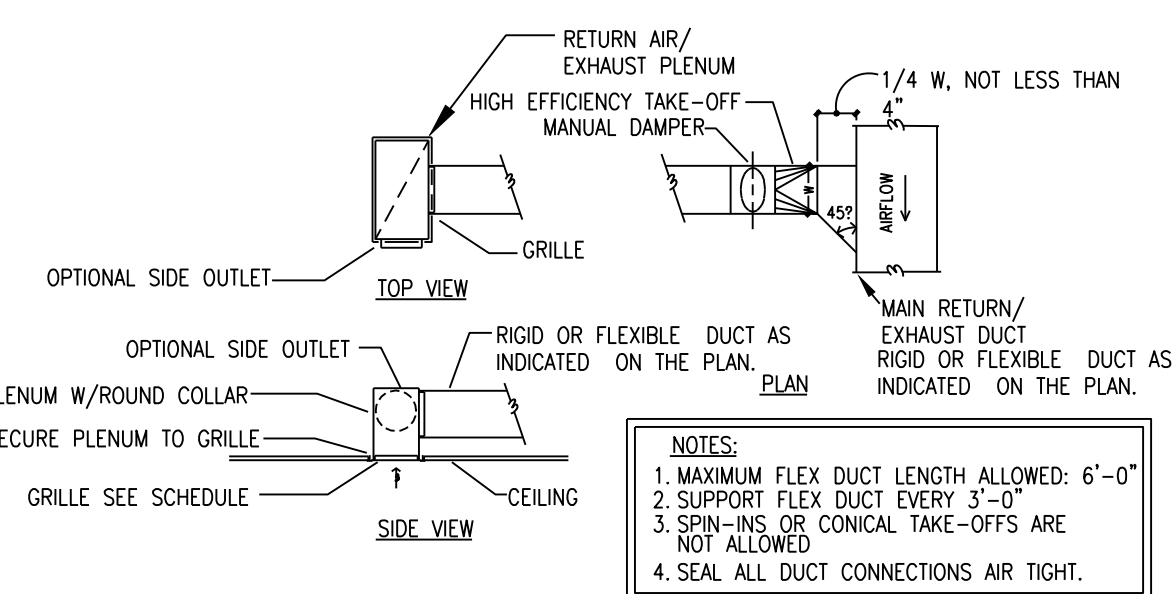
FIRST FLOOR VENTILATION DEMOLITION PLAN  
1/8"=1'-0"

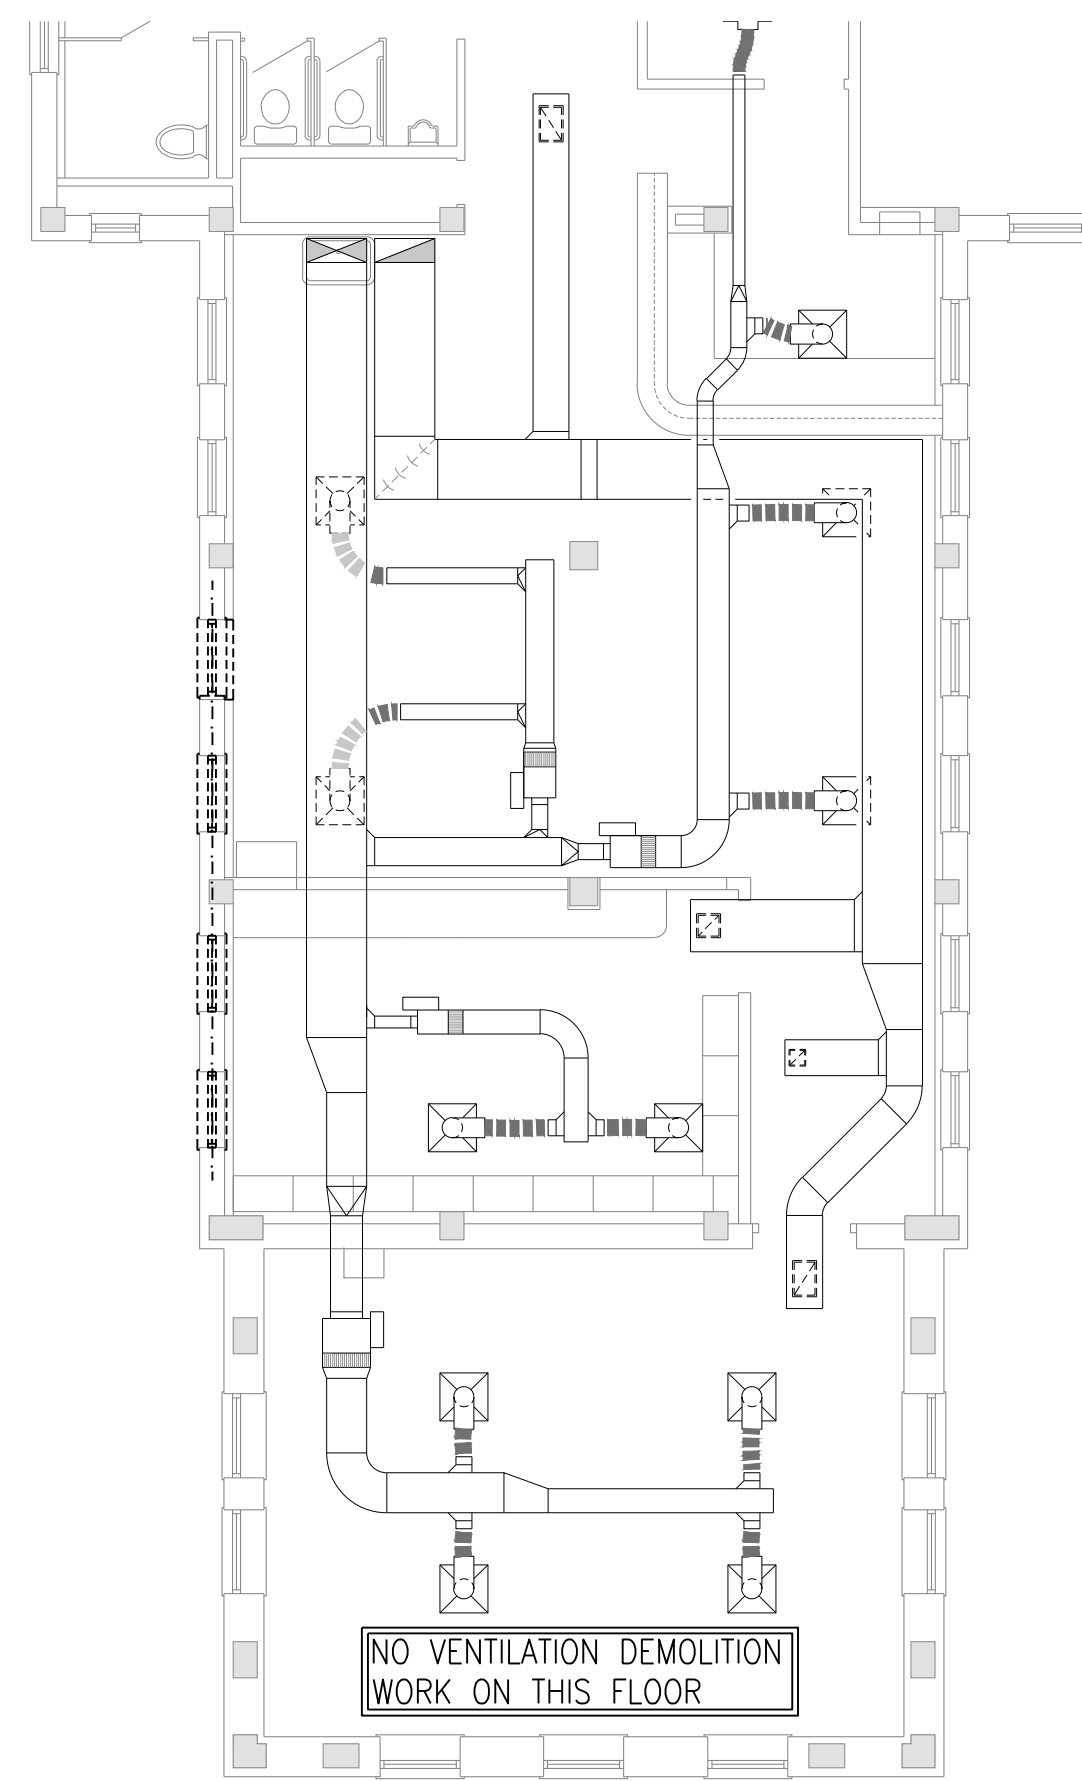


SECOND FLOOR VENTILATION DEMOLITION PLAN  
1/8"=1'-0"

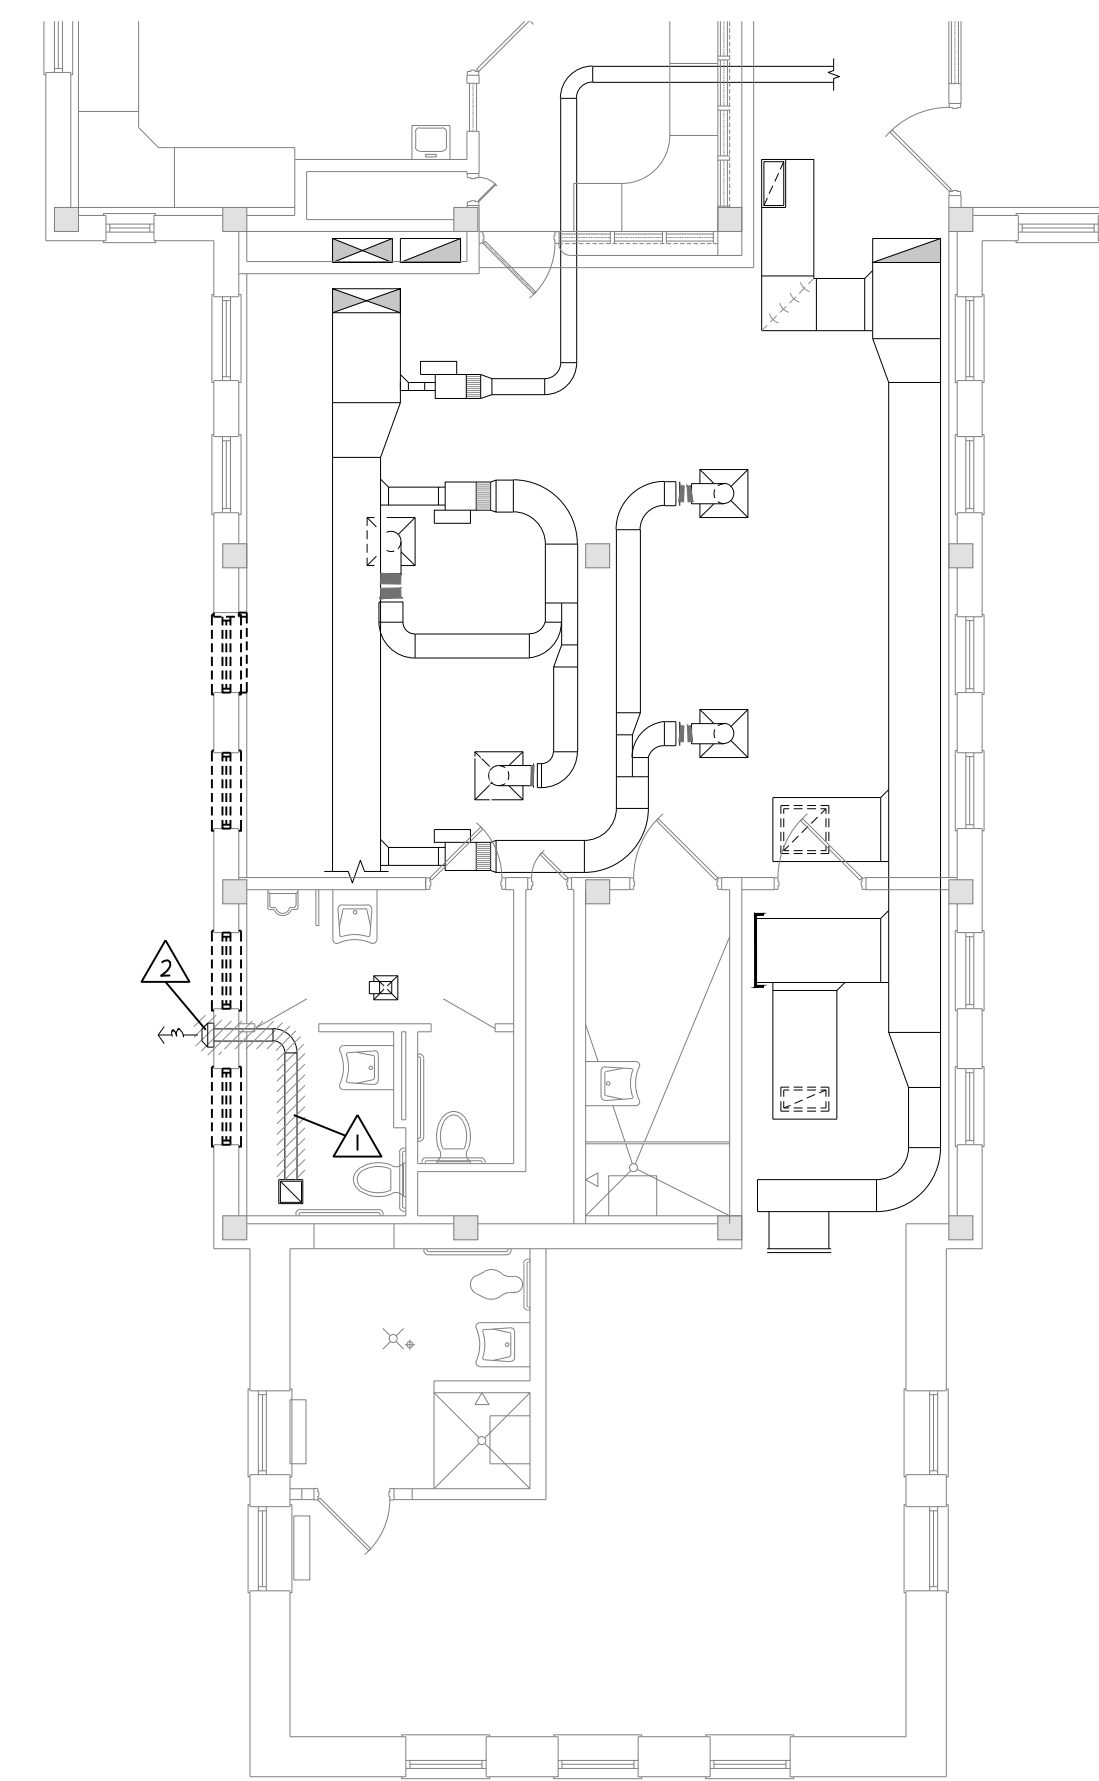


**SUPPLY DUCT TO DIFFUSER DETAIL**  
NO SCALE

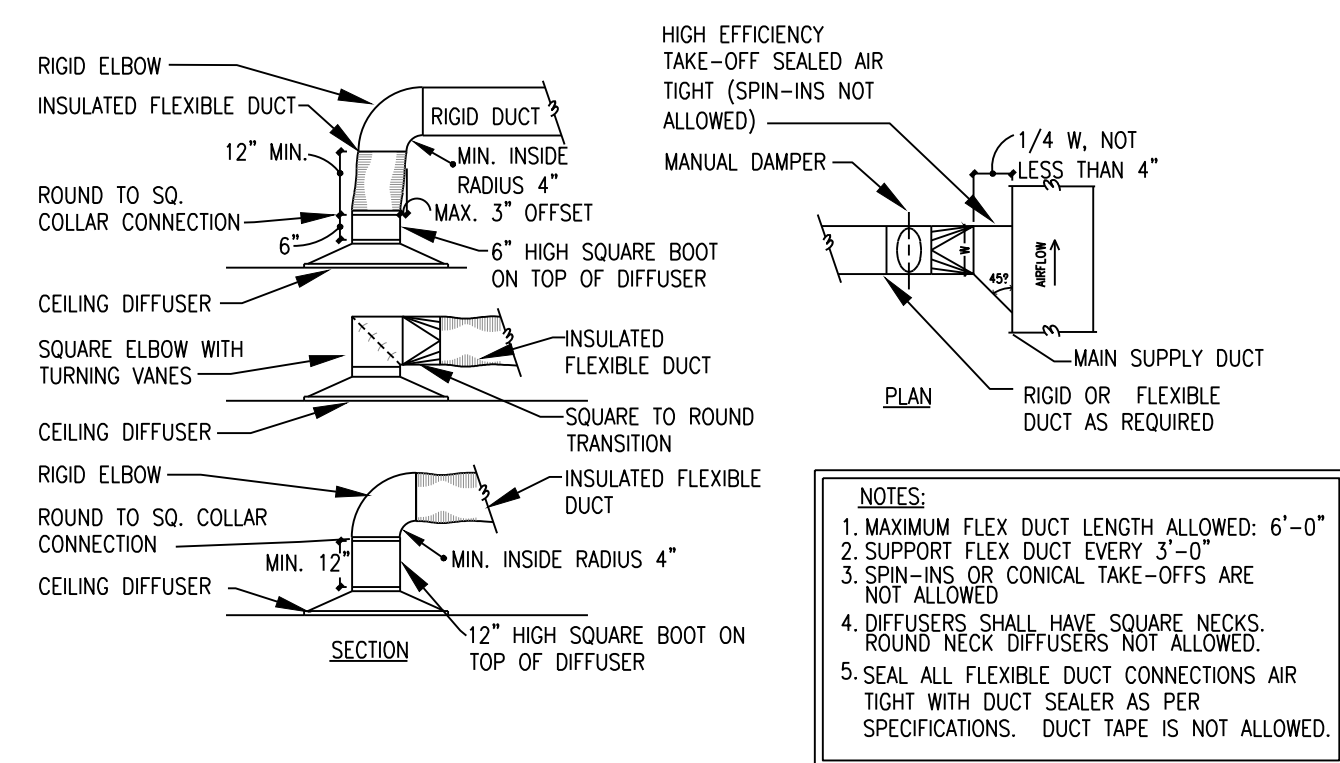


RETURN/EXHAUST DUCT TO GRILLE DETAIL  
NO SCALE

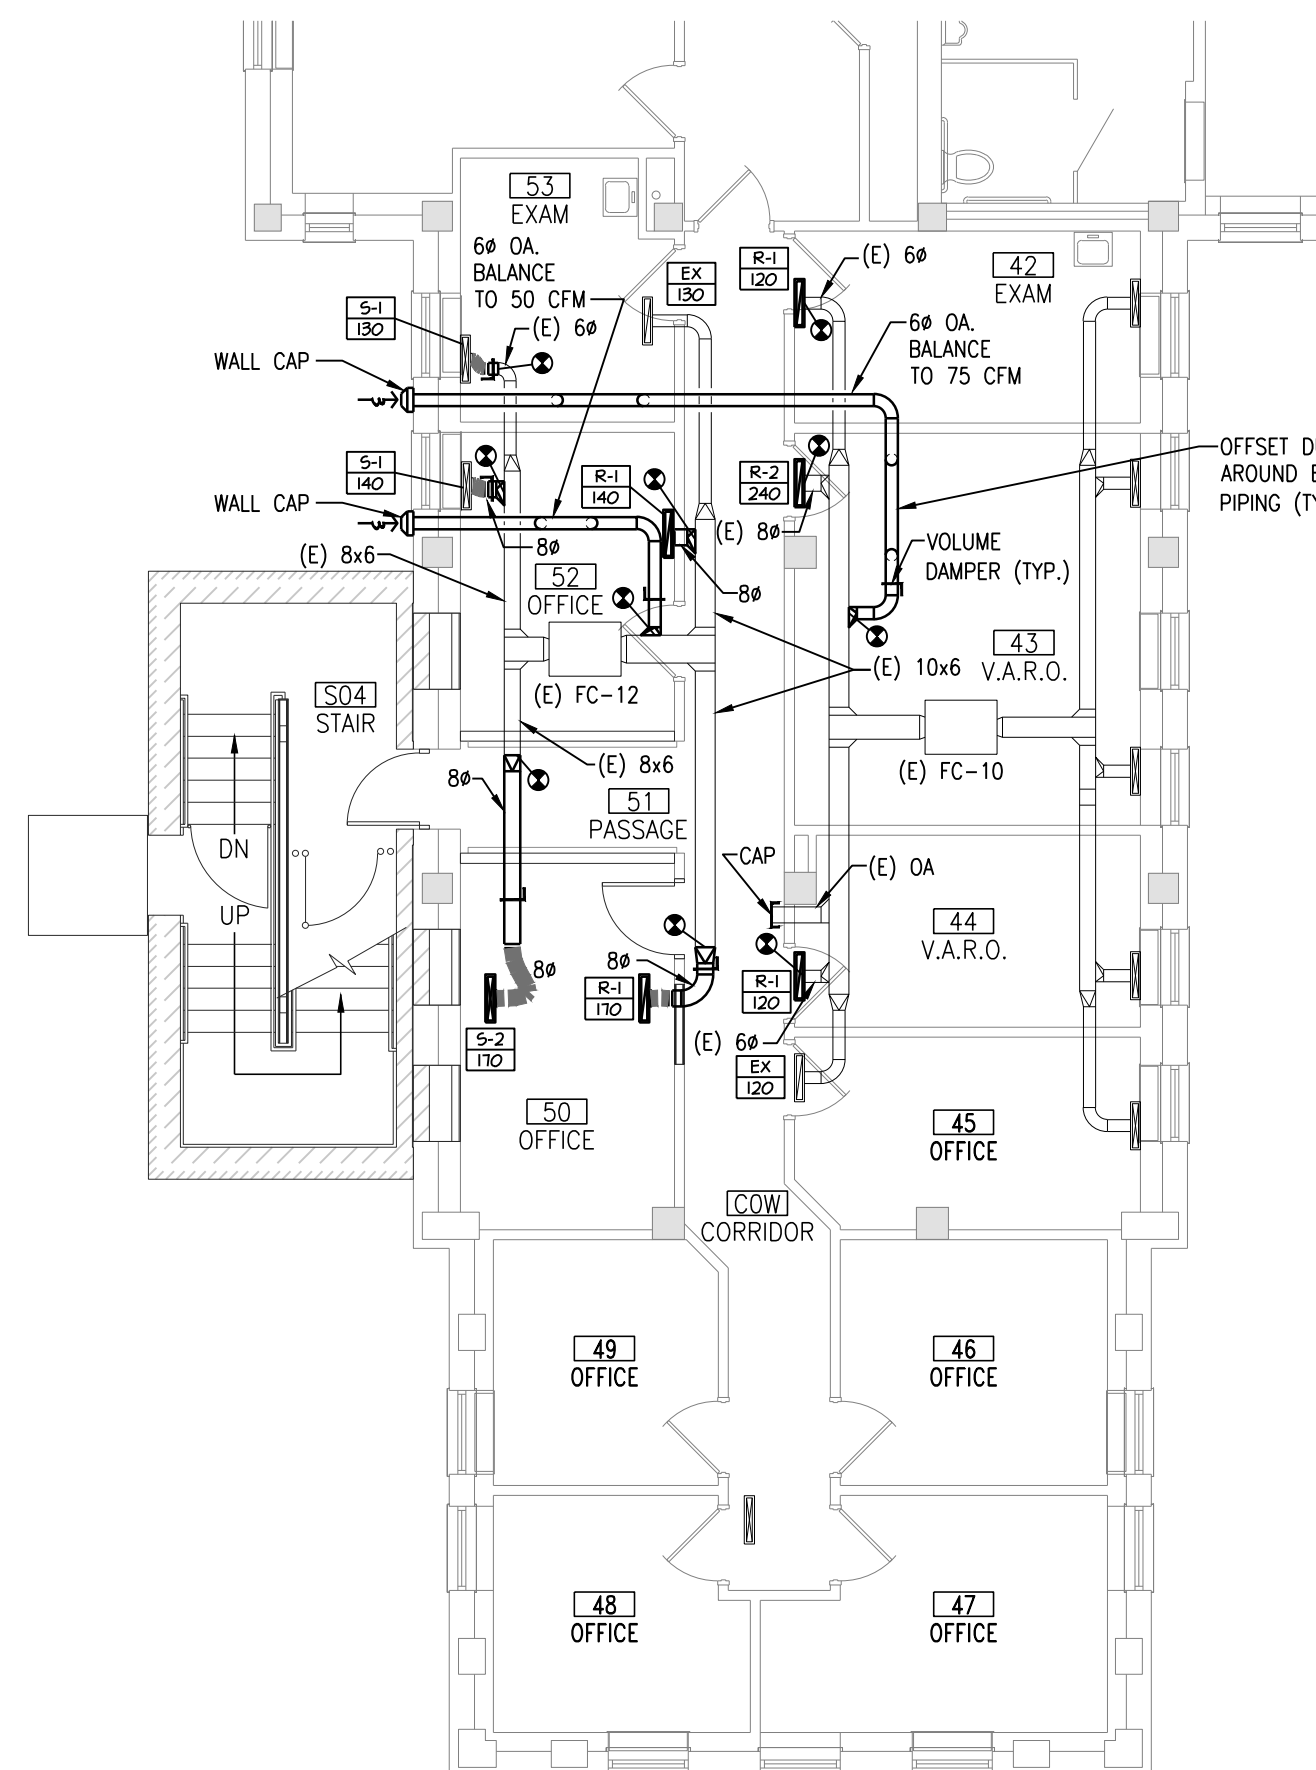

BASEMENT VENTILATION REMODELING PLAN  
1/8"=1'-0"

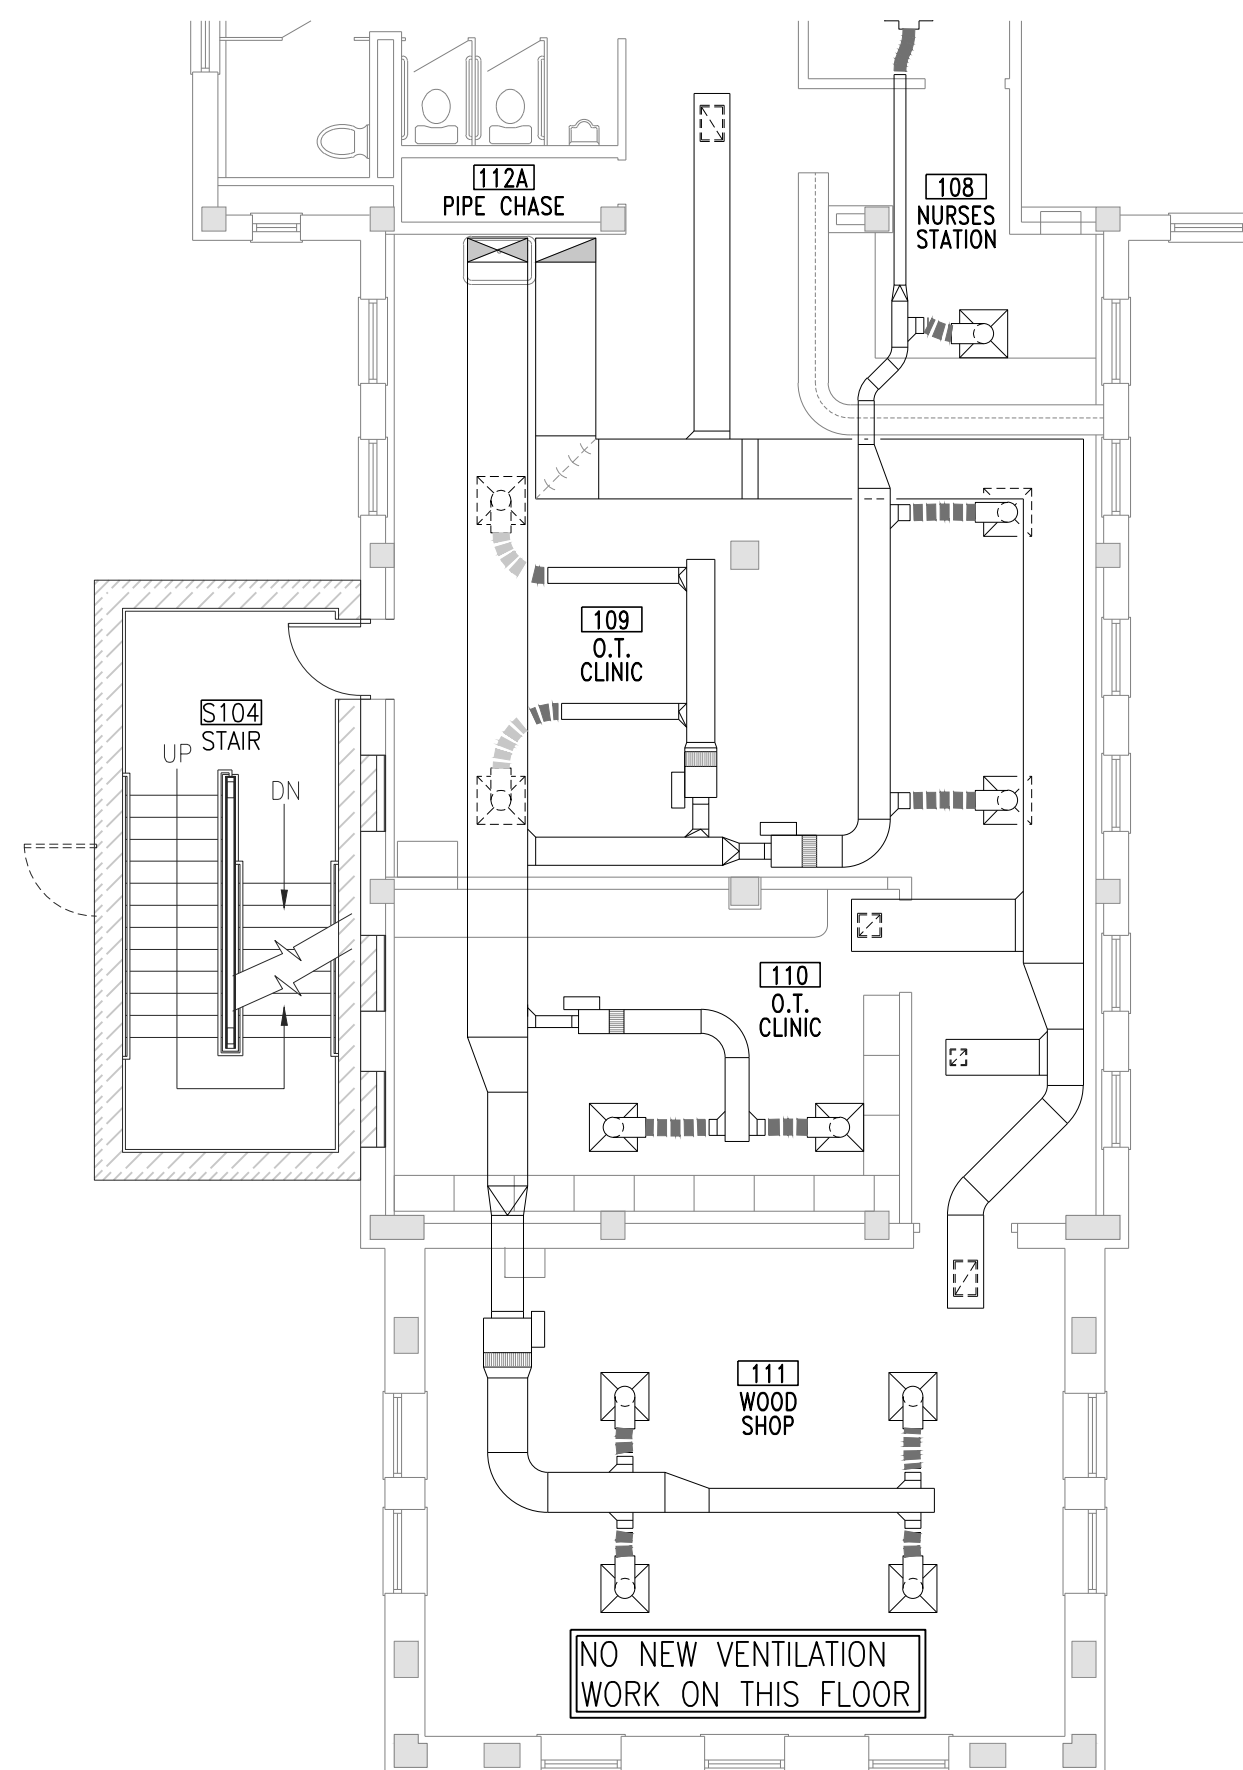

FIRST FLOOR VENTILATION REMODELING PLAN  
1/8"=1'-0"

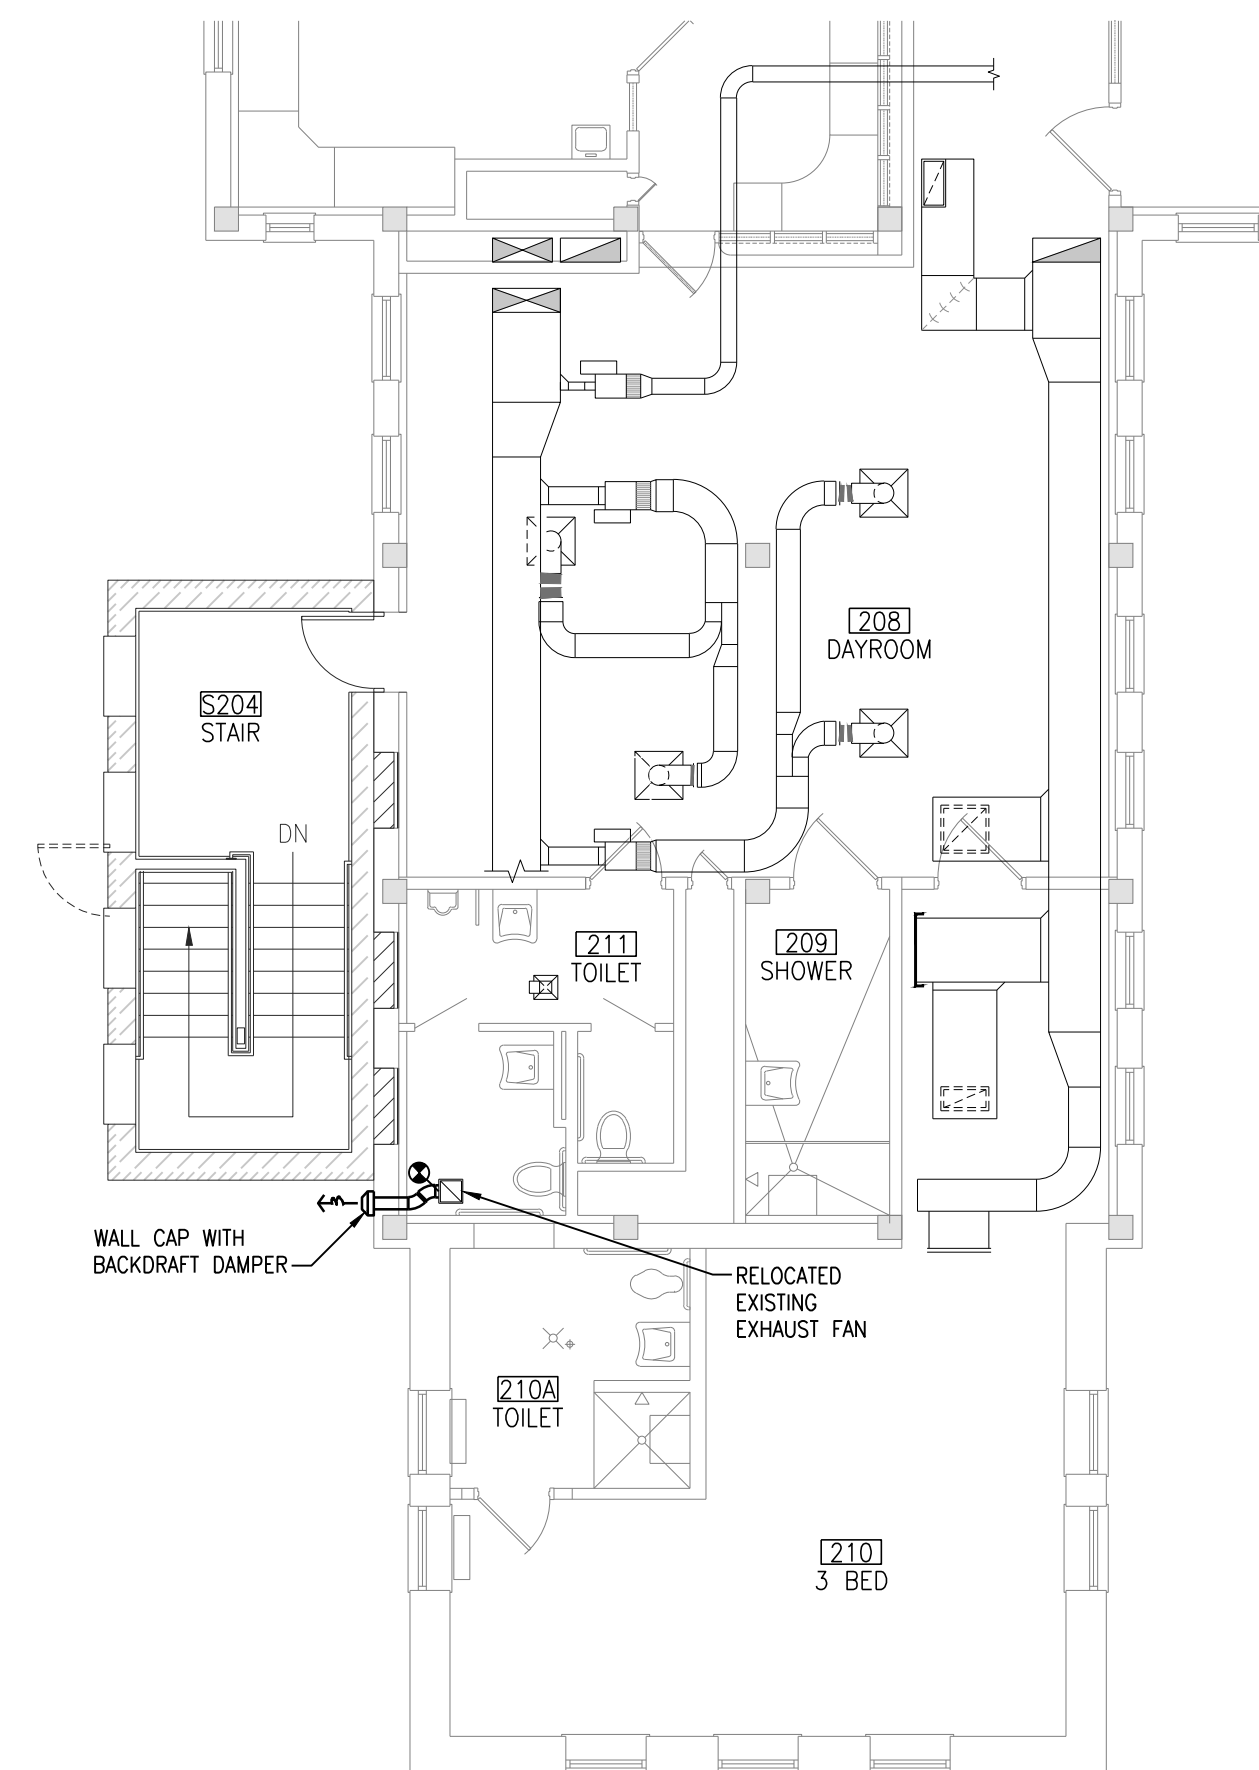

SECOND FLOOR VENTILATION REMODELING PLAN  
1/8"=1'-0"

## DEMOLITION NOTES:

- A. DEMOLITION DRAWINGS ARE DIAGRAMATIC ONLY AND NOT TO BE USED FOR ORDERING OR SCHEDULING EXISTING RECORD DRAWINGS. CONTRACTOR SHALL VERIFY ALL EXISTING CONDITIONS PRIOR TO BEGINNING WORK AND SHALL IMMEDIATELY NOTIFY ARCHITECT OF ANY DISCREPANCIES BETWEEN THE "AS-BUILT" CONDITION AND THESE DRAWINGS. PROVIDE ADDITIONAL DEMOLITION OR REPAIR DETAILS AS REQUIRED.
- B. THIS CONTRACTOR IS RESPONSIBLE FOR REMOVAL AND RE-INSTALLING OF EXISTING CEILING LINE AND RE-INSTALLING THE GENERAL CONTRACTOR FOR THE REMOVAL OF EXISTING VENTILATION EQUIPMENT, ETC. VERIFY WITH ARCHITECTURAL PLANS FOR CORRELATION BY THE GENERAL CONTRACTOR. ANY REMOVAL OF OR GRIND DOWN OF EXISTING CEILING SHALL BE REPLACED WITH NEW BY THIS CONTRACTOR.
- C. THIS CONTRACTOR SHALL REMOVE ALL WALLS AND/OR CEILING LINE AND EQUIPMENT OF EXISTING VENTILATION EQUIPMENT, ETC. AS REQUIRED.
- D. THIS CONTRACTOR IS RESPONSIBLE FOR PATCHING ALL HOLES/WALLS AND/OR CEILINGS FROM DEMOLISHED EXISTING EQUIPMENT, EQUIPMENT ETC. IN FLOORS, WALLS, AND CEILINGS TO MATCH EXISTING.

DISCONNECT AND REMOVE EXISTING DUCTWORK INCLUDING ALL ASSOCIATED SUPPLES, INSULATION, ETC. MEASURE INSIDE AIR FLOW VIA DUCT TRANSVERSE PRIOR TO BEGINNING WORK.

DISCONNECT AND REMOVE EXISTING CAP INTAKE WALL CAP INCLUDING ALL ASSOCIATED DUCTWORK, SUPPLES, INSULATION, ETC. MEASURE INSIDE AIR FLOW VIA DUCT TRANSVERSE PRIOR TO BEGINNING WORK.

DISCONNECT AND REMOVE EXISTING DUCTWORK, REGISTER, OR GRILLE INCLUDING ALL ASSOCIATED DUCTWORK, SUPPLES, INSULATION, ETC. CAP MEASURE INSIDE AIR FLOW AT DUCT TRANSVERSE AND DOCUMENT AIR FLOW AT DUCTIFIER PRIOR TO BEGINNING WORK.

DISCONNECT AND REMOVE EXISTING DUCTIFIER, REGISTER, OR GRILLE. PRESERVE REMAINING DUCTWORK FOR RE-CONNECTION. MEASURE AND DOCUMENT AIR FLOW AT DUCTIFIER PRIOR TO BEGINNING WORK.

DISCONNECT AND REMOVE EXISTING FRESH AIR INTAKE WALL CAP INCLUDING ALL ASSOCIATED DUCTWORK, SUPPLES, INSULATION, ETC. MEASURE OUTSIDE AIR FLOW VIA DUCT TRANSVERSE PRIOR TO BEGINNING WORK.

DISCONNECT AND DOCUMENT AIR FLOW AT DUCTIFIER PRIOR TO BEGINNING WORK.

## INSTALLATION NOTES:

- A. CONTRACTOR SHALL VERIFY ALL EXISTING CONDITIONS PRIOR TO BEGINNING WORK AND NOTIFY THE ARCHITECT/ENGINEER OF ANY DISCREPANCIES BETWEEN THE "AS-BUILT" CONDITIONS AND THESE DRAWINGS.
- B. COORDINATE ALL DUCTWORK INSTALLATION WITH GENERAL PLUMBING, FIRE PROTECTION, AND ELECTRICAL SYSTEMS. PROVIDE ALL DUCTWORK AS HIGH AS POSSIBLE. PROVIDE ALL NECESSARY OFFSETS (DROPS AND RISERS) TO KEEP DUCTWORK TIGHT TO STRUCTURE AND AVOID INTERFERENCE WITH ALL TRADES. OFFER DUCTWORK TO AVOID BEAMS.
- C. REFER TO AND COORDINATE WITH THE ARCHITECTURAL PLANS FOR CEILING TYPES, HEIGHTS, SLOPE AREAS, AND OTHER REQUIREMENTS FOR INSTALLATION OF NEW VENTILATION DUCTWORK, EQUIPMENT, ETC.
- D. THIS CONTRACTOR IS RESPONSIBLE FOR REMOVAL AND REPAIR OF EXISTING DUCTWORK OR EQUIPMENT TO BE REMOVED BY THE GENERAL CONTRACTOR FOR THE INSTALLATION OF NEW VENTILATION DUCTWORK. THE CONTRACTOR SHALL SUBMIT DETAILED REMEDIATION PLANS FOR CONSTRUCTION WORK BY THE GENERAL CONTRACTOR. REMOVE OR GRIND DOWN EXISTING DUCTWORK OR EQUIPMENT SHALL BE REPLACED WITH NEW BY THIS CONTRACTOR.
- E. THIS CONTRACTOR SHALL OPEN ALL EXISTING WALLS AND CEILINGS FOR INSTALLATION OF NEW VENTILATION DUCTWORK, EQUIPMENT, ETC. AS REQUIRED. PATCH WALLS AND/OR CEILINGS TO MATCH EXISTING.
- F. MAINTAIN 3'-0" CLEAR SPACE IN FRONT OF ALL ELECTRICAL, CONTROL, AND ACCESS PANELS FOR ACCESSIBILITY.
- G. ALL DAMPERS, ETC., SHALL BE INSTALLED IN ACCESSIBLE LOCATIONS.
- H. ALL OPEN ENDS OF DUCTS SHALL BE CAPPED AT THE END OF CONSTRUCTION EACH FLOOR.
- I. ALL WAX BOXES, TERMINAL COILS, ETC., SHALL BE LOOSELY PACKED AS POSSIBLE TO THE CONTROLLED DEVICES.